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JOB # A9494 DATE: 08-25-11

**REVISION:** DRAWN BY: JCD

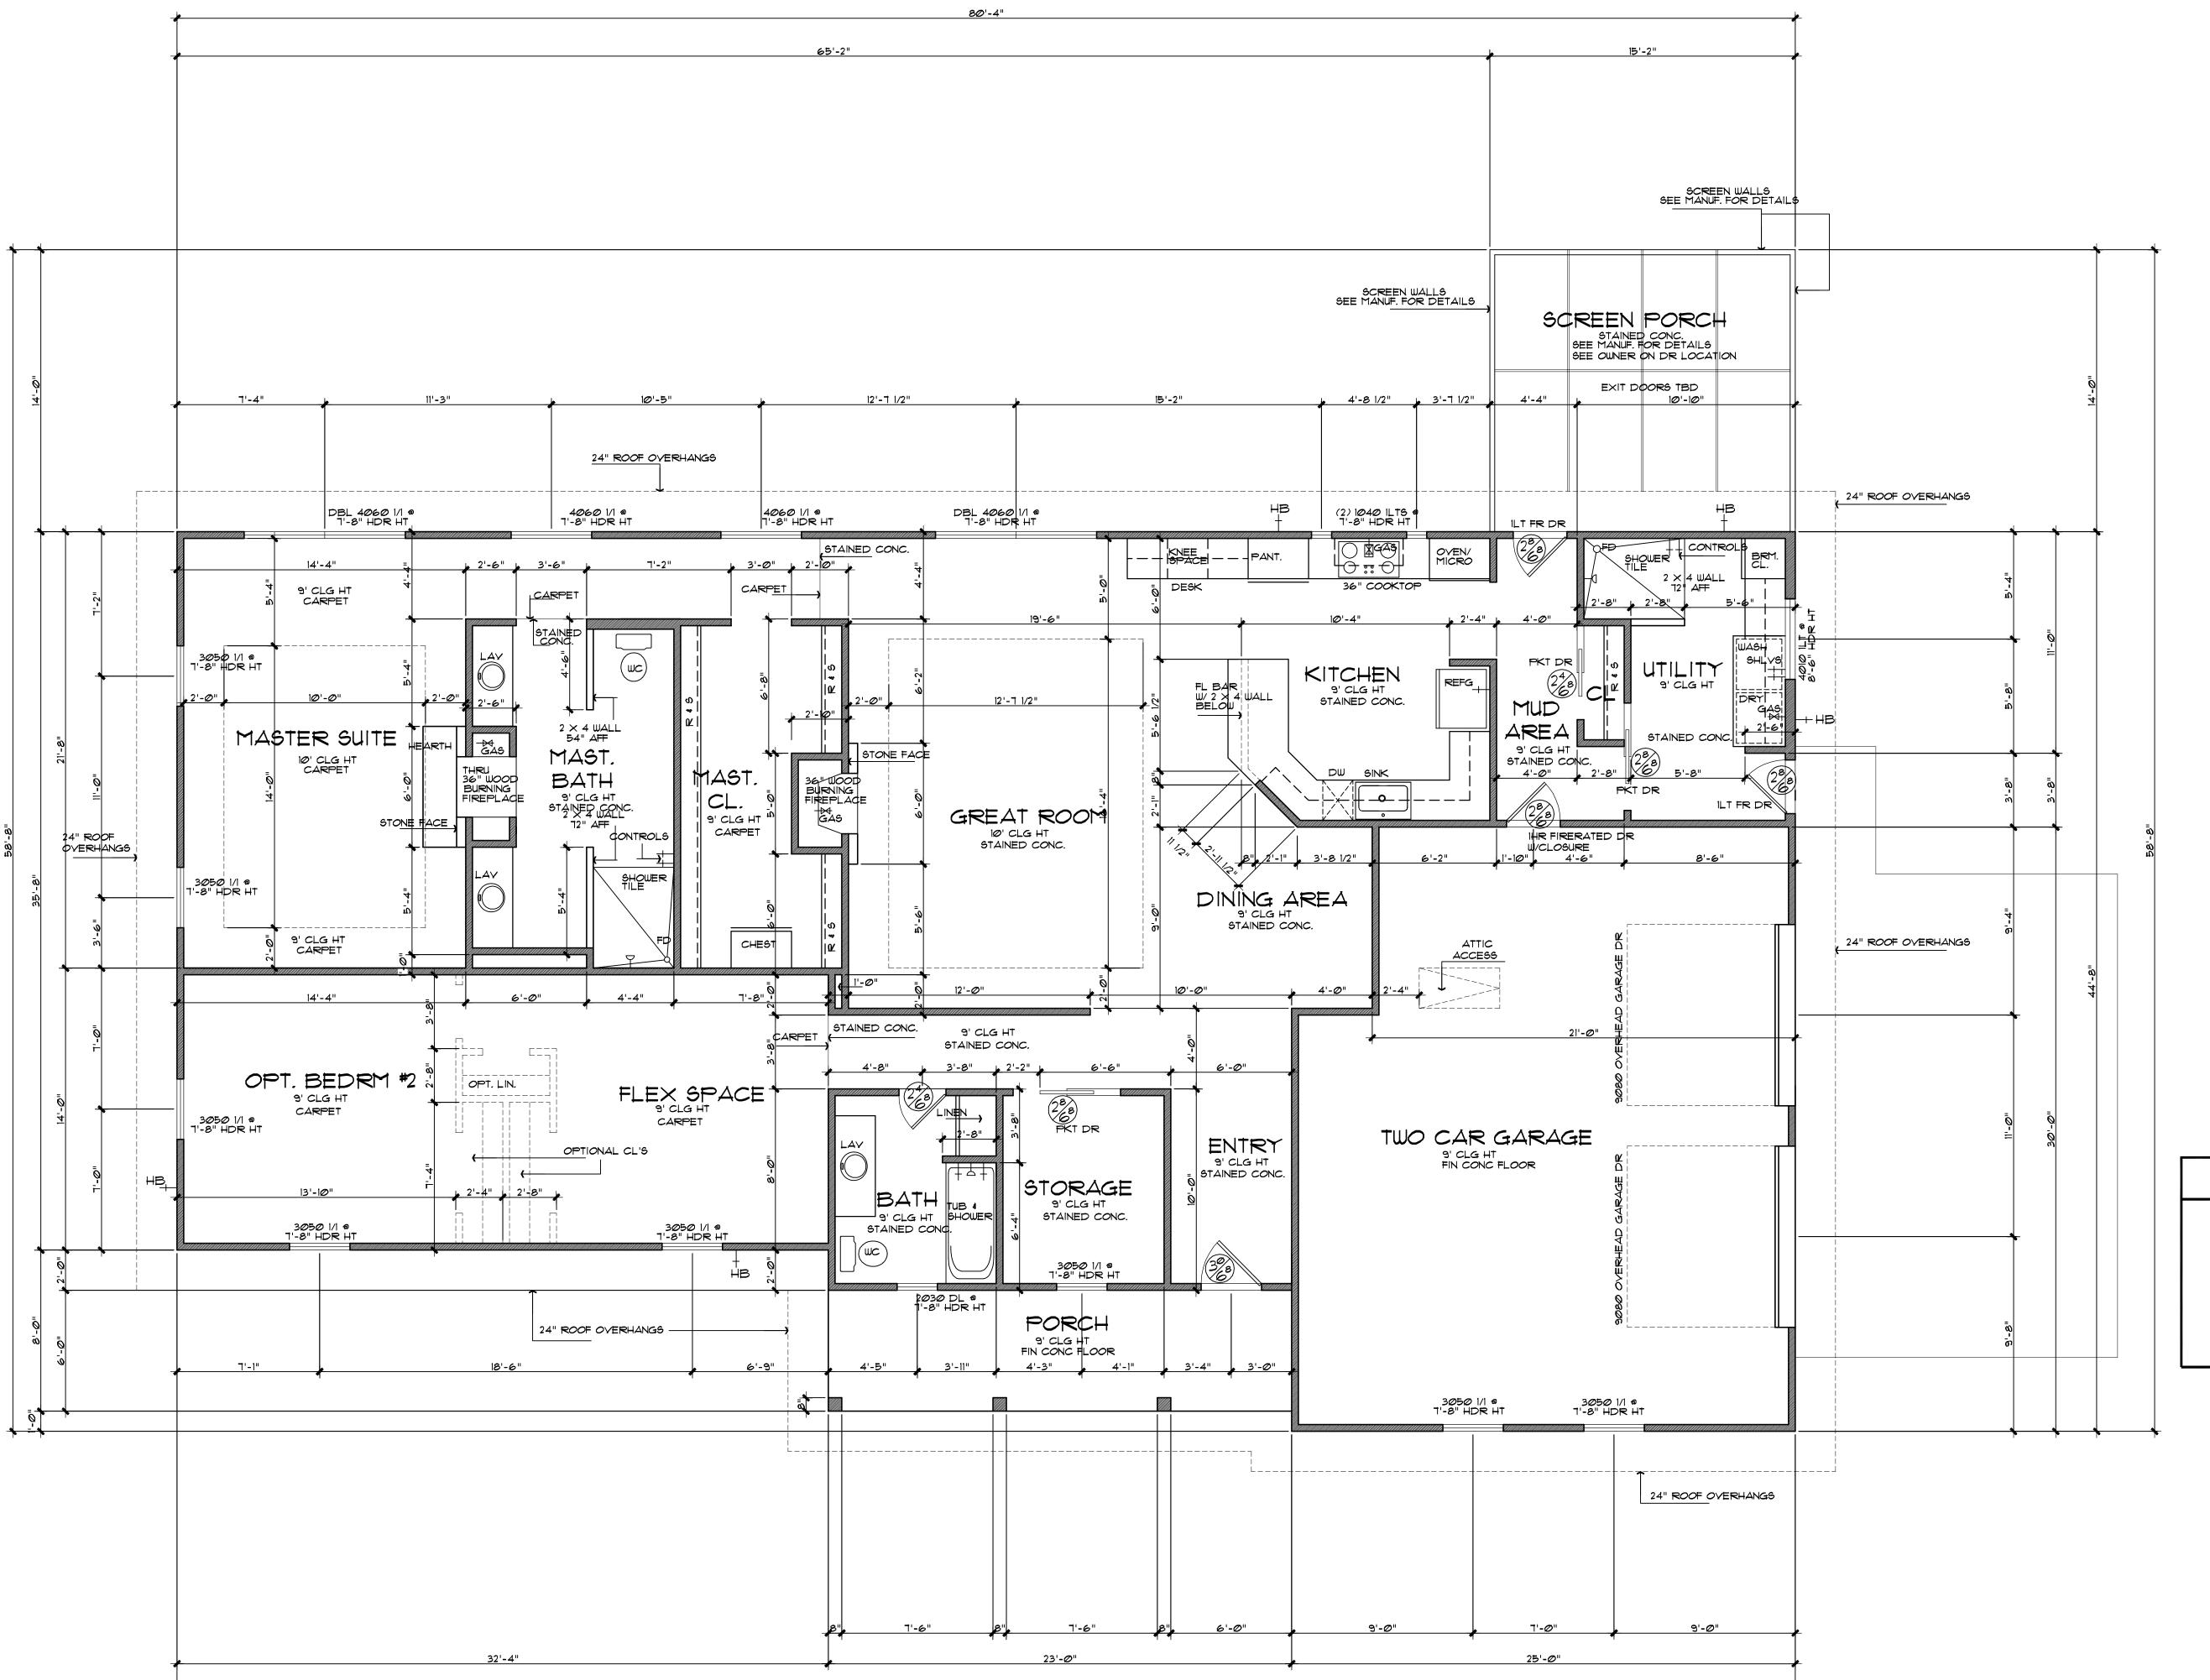
JOHN C. DAME, SR. #49

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FLOOR PLAN

SCALE: 1/4"=1'-0"



GENERAL NOTES:

- 2.0 These plans and specifications are intended to meet all applicable codes and ordinances. Contractor to comply with all local codes, ordinances and deed
- 3.0 Any discrepancies in plans to be brought to the attention of the designer prior to beginning construction. Contractors shall assume responsibility
- for errors that are not reported. 4.0 Contractor shall insure compatibility of the building
- with all site requirements. 5.0 Contractor to consult with a structural engineer for design of all solid framing, columns, beams, and other
- 6.0 All wood, concrete and steel structural members shall
- be of a good quality and meet all applicable national, state and local building codes. 7.0 All angles shown on plans are 45° unless noted otherwise.
- 8.0 All dimensions should be read or calculated and never scaled
- 9.0 All window sizes are nominal rough opening, verify sizes with manufacturers details 4 specs.
- 10.0 All windows will be dimensioned to center of rough openings unless otherwise noted. 11.0 Weather strip attic access door(s).
- 12.0 Contractor to provide a 3/4" plywood catwalk from attic access to HVAC units (if applicable). Units
- to be located within 20'-0" of access 13.0 All vents to rear of residence. 14.0 Provide 1 s.f. net free area of attic ventilation per
- 150 s.f. of total covered roof area as per code. 15.0 Floor truss area to be draft stopped where trusses
- open to attic space 16.0 Divide floor truss area into equal areas of less than 1000 s.f. each for fire stops
- 17.0 Provide control and expansion joints as required on concrete drives, walks, patios and masonry walls.
- 18.0 Pull down atticc access to be standard 30"x54" RO. all ceilings 11'-1 1/8" or higher require 30"x60" RO.
- 19.0 Provide studs at all 4 corners of tub. 200 Provide 5/8" type "X" gypsum board on common walls
- and ceilings. 21.0 Do not use wood build-outs behind stucco, around
- windows and doors. 22.0 Attach tops, sides and bottoms, of windows and doors shingle style.
- 23.0 Apply 2 ply ALTM building paper shingle style over all exterior sheating prior to installing metal roof.
- 24.0 Stucco veneer must comply with 2006 IRC and the ASTM requirements.
- 25.0 Provide weep screen properly installed.
- 26.0 Provide expansion/contraction control joints to divide up stucco into 100 sq. ft. total sq. ft. area. Provide casing bead where stucco terminates around perimeter of windows, doors or dissimilar materials. Stop casing bead at least  $\frac{3}{6}$ " to  $\frac{1}{2}$ " away from window and door frames.

AREA'S	
TOTAL LIVING	2431
PORCH	136
SCREEN PORCH	212
GARAGE-	704
TOTAL COVERED	3483

## SYMBOL LEGEND

GAS/PROPANE YALVE

HOSE BIB

SHOWER HEAD @ 84" AFF

DOOR SIZE TAG