
VAN ZANTEN RESIDENCE 1919 BERRY STREET NE OLYMPIA, WASHINGTON

JUNE, 2006

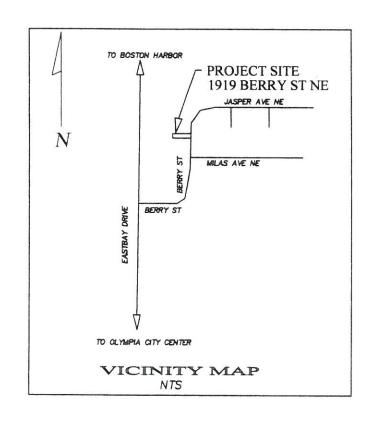

PROJECT PROPONENT

BAREND VAN ZANTEN P.O. BOX 7279 OLYMPIA, WA 98507 (360) 866-3929

SITE ADDRESS

1919 BERRY ST NE OLYMPIA, WA 98506

PARCEL # 4930050300

SHEET INDEX

SHEET # SHEET TITLE

--- COVER

1 T.E.S.C. PLAN

2 ON—SITE DRAINAGE PLAN

3 OFF—SITE DRAINAGE PLAN AND PROFILE

4 ON—SITE STORM LINE PROFILES

5 NOTES AND DETAILS


6 ROOF AND FOUNDATION DRAINAGE


LEC	GEND
	PROPOSED STORM DRAIN MANHOLE STORM DRAIN CULVERT STORM CATCH BASIN FLOW PATH FINISHED GRADE SPOT ELEVATION
	EXISTING
	RIGHT OF WAY LINE EDGE OF PAVEMENT PROPERTY LINE
1	FLOW PATH
===	STORM CULVERT
•	FOUND CORNER
□₩	WATER METER
	CATCH BASIN
7%	POWER POLE
× SPOT	GUY ANCHOR SPOT ELEVATION


BY:	APPROVED FOR CONSTRCTION DATE:
Engineering Plane Examinar	
APPROVAL EXPIRES:	

MATTHEWS ENGINEERING SERVICES

BRIAN K. MATTHEWS, P.E. PHONE: (360) 701-4152 DRAWING DATE: MAY 7, 2006 3230 CAIN RD SE DLYMPIA, WA 98501

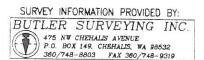

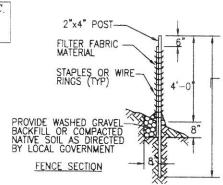

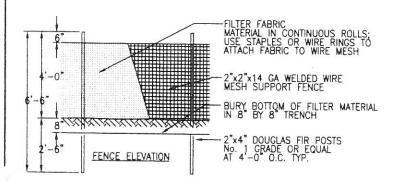

MAINTENANCE STANDARDS NOTES:

MAINTENANCE STANDARDS NOTES:

ANY DAMAGE SHALL BE REPAIRED IMMEDIATELY.

IF CONCENTRATED FLOWS ARE EVIDENT UPHILL OF THE FENCE, THEY MUST BE INTERCEPTED AND CONVEYED TO A SEDIMENT TRAP OR POND.

IT IS IMPORTANT TO CHECK THE UPHILL SIDE OF THE FENCE FOR SIGNS OF THE FENCE CLOGGING AND ACTING AS A BARRIER TO FLOW AND THEN CAUSING CHANNEUZATION OF FLOWS PARALLEL TO THE FENCE. IF THIS OCCURS, REPLACE THE FENCE OR REMOVE THE TRAPPED SEDIMENT.

SEDIMENT MUST BE REMOVED WHEN THE SEDIMENT IS 6 INCHES HIGH.

IF THE FILTER FABRIC (GEOTEXTILE) HAS DETERIORATED DUE TO ULTRAVIOLET BREAKDOWN, IT SHALL BE REPLACED.

TEMPORARY EROSION CONTROL FENCE

TEMPORARY EROSION AND SEDIMENT CONTROL NOTES:

1. APPROVAL OF THIS EROSION SEDIMENTATION CONTROL (ESC) PLAN DOES NOT CONSTITUTE AN APPROVAL OF PERMANENT ROAD OR DRAINAGE DESIGN (E.G. SIZE AND LOCATION OF ROADS, PIPES, RESTRICTORS, CHANNELS, RETENTION FACILITIES, UTILITIES, ETC).

2. THE IMPLEMENTATION OF THESE ESC PLANS AND THE CONSTRUCTION, MAINTENANCE, REPLACEMENT, AND UPGRADING OF THESE ESC FACILITIES IS THE RESPONSIBILITY OF THE CONTRACTOR UNTIL ALL CONSTRUCTION IS APPROVED.

- 3. THE BOUNDARIES OF THE CLEARING LIMITS SHOWN ON THIS PLAN SHALL BE CLEARLY FENCED AND/OR FLAGGED AS CALLED OUT ON THE PLAN PRIOR TO CONSTRUCTION. DURING THE CONSTRUCTION PERIOD, NO DISTURBANCE BEYOND THE CLEARING LIMITS SHALL BE PERMITTED. THE FENCING/FLAGGING SHALL BE MAINTAINED BY THE CONTRACTOR FOR THE DURATION OF THE CONSTRUCTION.
- 4. THE ESC FACILITIES SHOWN ON THIS PLAN MUST BE CONSTRUCTED IN CONJUNCTION WITH ALL CLEARING AND GRADING ACTIVITIES, AND IN SUCH A MANNER AS TO INSURE THAT SEDIMENT LADEN WATER DOES NOT ENTER THE DRAINAGE SYSTEM, WETLANDS, OR DRAINAGE COURSES, OR VIOLATE APPLICABLE WATER STANDARDS.
- 5. THE ESC FACILITIES SHOWN ON THIS PLAN ARE THE INIMUM REQUIREMENTS FOR ANTICIPATED SITE CONDITIONS. JURING THE CONSTRUCTION PERIOD, THESE ESC FACILITIES SHALL BE UPGRADED (E.G. ADDITIONAL SUMPS. RELOCATION OF DITCHES AND SILT FENCES, ETC) AS NEEDED FOR UNEXPECTED STORM EVENTS.

- 6. THE ESC FACILITIES SHALL BE INSPECTED DAILY BY THE CONTRACTOR AND MAINTAINED AS NECESSARY TO ENSURE THEIR CONTINUED FUNCTIONING.
- 7. ANY AREA STRIPPED OF VEGETATION, INCLUDING ROADWAY EMBANKMENTS, WHERE NO FURTHER WORK IS ANTICIPATED FOR A PERIOD OF FIFTEEN (15) DAYS, SHALL BE IMMEDIATELY STABILIZED WITH THE APPROVED ESC METHODS (E.G. SEEDING, MULCHING, NETTING, EROSION BLANKETS, ETC.).
- 8. ANY AREA NEEDING ESC MEASURE, NOT REQUIRING IMMEDIATE ATTENTION, SHALL BE ADDRESSED WITHIN FIFTEEN (15) DAYS.
- 9. THE ESC FACILITIES ON INACTIVE SITES SHALL BE INSPECTED AND MAINTAINED A MINIMUM OF ONCE A MONTH OR WITHIN THE 48 HOURS FOLLOWING A STORM EVENT. 10. AT NO TIME SHALL MORE THAN ONE FOOT OF SEDIMENT BE ALLOWED TO ACCUMULATE WITHIN A CATCH BASIN. ALL CATCH BASINS AND CONVEYANCE LINES SHALL BE CLEANED PRIOR TO PAVING. THE CLEANING OPERATION SHALL NOT FLUSH SEDIMENT LADEN WATER INTO THE DOWNSTREAM SYSTEM.
- 11. STABILIZED CONSTRUCTION ENTRANCE AND WASH PAD SHALL BE INSTALLED AT THE BEGINING OF CONSTRUCTION AND MAINTAINED FOR THE DURATION OF THE PROJECT. ADDITIONAL MEASURES MAY BE REQUIRED TO INSURE THAT ALL PAVED AREAS AND PUBLIC STREETS ARE KEPT CLEAN FOR THE DURATION OF THE PROJECT. 12. DURING THE TIME PERIOD OF NOVEMBER 1 THROUGH MARCH 31 ALL PROJECT DISTURBED AREAS GREATER THAN 5,000 SQUARE FEET SHALL BE COVERED BY ONE OF THE FOLLOWING COVER MEASURES: MULCH, SODDING OR PLASTIC COVERING.

13. ANY PERMANENT RETENTION/DETENTION FACILITY USED AS A TEMPORARY SETTLING BASIN SHALL BE MODIFIED WITH THE NECESSARY EROSION CONTROL MEASURES AND SHALL PROVIDE ADEQUATE STORAGE CAPACITY. IF THE PERMANENT FACILITY IS TO FUNCTION ULTIMATELY AS AN INFILTRATION OR DISPERSION SYSTEM, THE FACILITY SHALL NOT BE USED AS TEMPORARY SETTLING BASIN. NO UNDERGROUND DETENTION TANKS OR VAULTS SHALL BE ITSED AS A TEMPORARY SETTLING BASIN USED AS A TEMPORARY SETTLING BASIN. 14. WHERE MULCH FOR TEMPORARY EROSION CONTROL IS REQUIRED, IT SHALL BE APPLIED AT MINIMUM THICKNESS OF TWO INCHES, NO STRAW OR HAY BALES PERMITTED.

SEC. 11, T18N, R2W

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S 87'58'07" F

N 8758'07" W 107.68

15. PERMANENT SLOPES AND EXPOSED AREAS AT FINAL GRADE SHALL BE STABILIZED AND PLANTED PER THE LANDSCAPE PLANS.

1. INSTALL SEDIMENT SOCK IN NEW TYPE I CATCH BASINS AFTER THEIR INSTALLATION.

NOTES

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2. DO NOT REMOVE FILTER FENCE UNTIL GROUND COVER HAS BEEN ESTABLISHED AND APPROVED BY THE ENGINEER.



Basis of bearings: City of Olympia Boundary Line Adjustment Number BLA-00-1050-0L as recorded under AFN 3304059, Records of Thurston County, Washington

THE CONTRACTOR SHALL VERIFY ALL UTILITY LOCATIONS PRIOR TO CONSTRUCTION BY CALLING THE UNDERGROUND LOCATE LINE AT 1-800-424-5555

CONSTRUCTION ENTRANCE SEE DETAIL 1 ON SHEET 5

Concrete


R/W


A MINIMUM OF 48 HOURS PRIOR TO ANY EXCAVATION. THE CONTRACTOR WILL ALSO BE RESPONSIBLE FOR MAINTAINING ALL LOCATE MARKS ONCE THE UTILITIES HAVE BEEN LOCATED.


BY: Engineering Plans Examiner	APPROVED FOR CONSTRCTION DATE:
APPROVAL EXPIRES:	

1" = 10'


MATTHEWS ENGINEERING SERVICES SIZED Cath Ref ST. Phaner C3550 555-5770		VAN ZANTEN 1919 BERRY STREET RESIDEN T.E.S.C PLA	
DESIGN BY, BRIAN MATTHEWS			SHEET 0
DRAWN BY BRIAN MATTHEWS			
CHECKED BY: BRIAN MATTHEWS	ENGINEER'S JOB #	I REVISED PER OLYMPIA COMMENTS	05/07/06 1 OF 6
DRAWING DATE	03002	REV. # NOTE	1331.001 1 3. 0

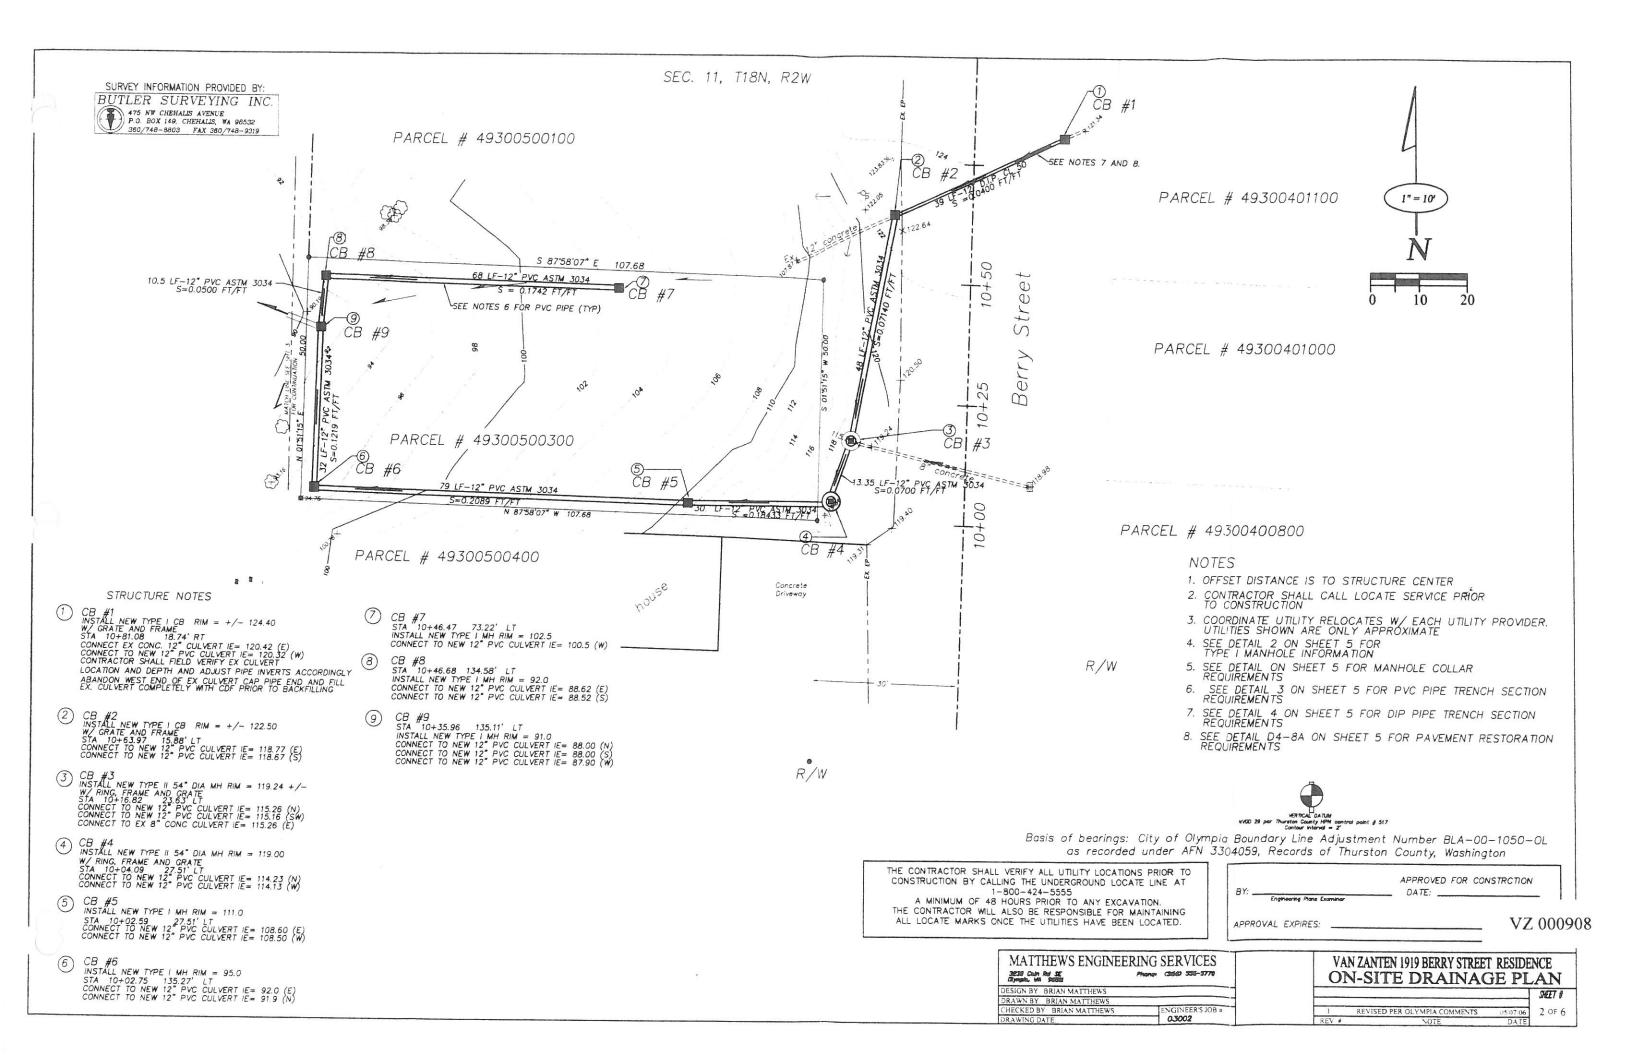

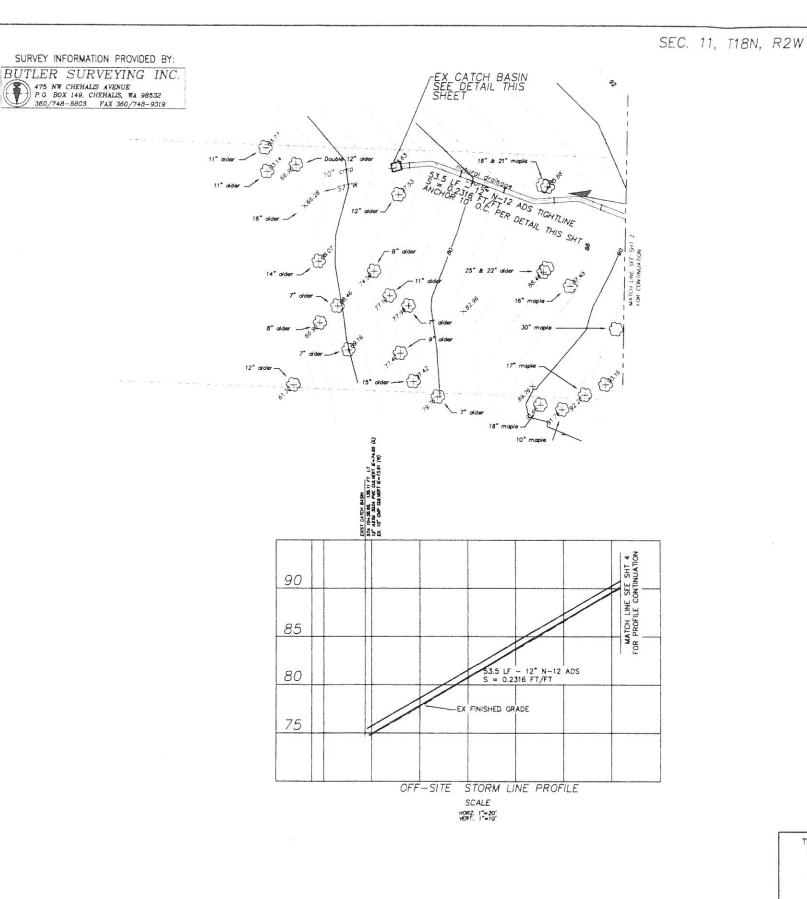

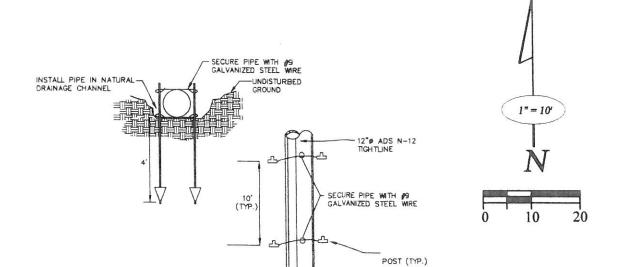

DRAINLINE ANCHOR

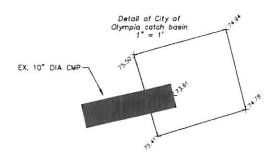

EXISTING CATCH BASIN



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Engineering Plane Examiner	
APPROVAL EXPIRES:	VZ 0009

MATTHEWS ENGINEERING SERVICES SECTION COLUMN ROLL ST. Phonor COSCO 5555-5770 SUPPLIA IN SECTION COLUMN SECTIO			VAN ZANTEN 1919 BERRY STREET RESIDENCE OFF-SITE DRAINAGE PLAN AND PROFILE		
DESIGN BY BRIAN MATTHEWS					SHEET 8
DRAWN BY BRIAN MATTHEWS					
CHECKED BY BRIAN MATTHEWS	ENGINEER'S JOB #	1	REVISED PER OLYMPIA COMMENTS	05/07/06	3 of 6
DRAWING DATE: 05/07/06	03002	REV #	NOTE	DATE	

