

GENERAL NOTES

1.1 Fabrication shall be in accordance with A.S.C. standard practices in compliance with the applicable sections, relating to design requirements and allowable stresses of the latest edition of the "AWS Structural Welding Code D1.1 and D1.3".

| | ASTM DESIGNATION | MIN. YIELD STRENGTH |
|---------------------------------------|------------------|---------------------|
| Hot Rolled Steel Shapes (W, S, C & L) | A572 | Fy = 50 KSI |
| Steel Pipes | A500 | Fy = 42 KSI |
| Structural Tubing | A500 | Fy = 42 KSI |
| Structural Steel Web Plate | A572/A1011 | Fy = 50 KSI |
| Structural Steel Flange Plates/Bars | A529/A572 | Fy = 50 KSI |
| Cold Formed Light Gage | A653/A1011 | Fy = 50, 55 KSI |
| Roof and Wall Sheets | A792/A653 | Fy = 50, 80 KSI |
| Cable Brace | A475 - TYPE 1 | Extra High Strength |
| Rod Brace | A36 | Fy = 36 KSI |
| | | |
| Machine Bolts & Nuts | A307 | Fu = 60 KSI |
| High Strength Bolts (1" and less) | A325-TYPE 1 | Fu = 120 KSI |
| High Strength Bolts (>1" to 1 1/2") | A325-TYPE 1 | Fu = 105 KSI |
| Anchor Bolts (if supplied) | A36/A307/F1554 | Fu = 60 KSI |

1.3 PRIMER
Shop primer paint is a rust inhibitive primer which meets the end performance of Federal Specification SSPC No. 15 and is A.S.C. Gray Oxide color. This paint is not intended for long term exposure to the elements. A.S.C. is not responsible for any deterioration of the shop primer paint as a result of improper handling and/or jobsite storage. A.S.C. shall not be responsible for any field applied paint and/or coatings. (Section 6.5 AISC Code of Standard Practice, 9th Edition). Nominal thickness of primer will be 1 mil unless otherwise specified in contract documents.

1.4 GALVANIZED OR SPECIAL COATINGS:
See Contract Documents

- 1.5 ALL BOLTS ARE 1/2"Ø x 0'-1 1/4" A307 EXCEPT :
 a) Endwall rafter splice - 5/8"Ø x 0'-1 3/4" A325-N
 b) Endwall column to rafter connection - 5/8"Ø x 0'-1 1/2" A325-N
 c) Main frame connections - SEE CROSS SECTION
 d) Flange Brace connections - 1/2"Ø x 0'-1 1/4" A325

NOTE: Washers are not supplied unless noted otherwise on drawing

1.6 A325 BOLT TIGHTENING REQUIREMENTS

All high strength bolts are A325-N unless specifically noted otherwise. Structural bolts shall be tightened by the turn-of-the-nut method in accordance with the 9th Edition AISC "Specification for Structural Joints" using ASTM A325 or A490 Bolts, when specifically required. A325-N bolts are supplied without washer unless otherwise noted on the drawing.

All bolted connections unless noted are designed as bearing type connections with bolt threads not excluded from the shear plane.

1.7 CLOSURE STRIPS ARE FURNISHED FOR APPLICATION:

INSIDE- Under roof panels at eave & base
OUTSIDE - Between endwall panels and rake trim
- Under continuous ridge vent skirts

1.8 ERECTION NOTE:
All bracing, strapping, & bridging shown and provided by A.S.C. for this building is required and shall be installed by the erector as a permanent part of the structure. If additional bracing is required for stability during erection, it shall be the erector's responsibility to determine the amount of such bracing and to procure and install as needed.

1.9 ERECTION AND UNLOADING NOT BY A.S.C.

1.10 SHORTAGES
Any claims or shortages by buyer must be made to A.S.C. within five (5) working days after delivery, or such claims will be considered to have been waived by the customer and disallowed.

1.11 CORRECTIONS OF ERRORS AND REPAIRS (MBMA 6.1Q)
Claims for correction of alleged misfits will be disallowed unless A.S.C. shall have received prior notice thereof and allowed reasonable inspection of such misfits. The correction of minor misfits by the use of drift pins to draw the components into line, moderate amounts of reaming, chipping and cutting, and the replacement of minor shortages of material are a normal part of erection and are not subject to claim. No part of the Building may be returned for alleged misfits without the prior approval of A.S.C.

BUYER/END USE CUSTOMER RESPONSIBILITIES

2.1 It is the responsibility of the BUYER/END USE CUSTOMER to obtain appropriate approvals and secure necessary permits from City, County, State, or Federal Agencies as required, and to advise/release A.S.C. to fabricate upon receiving such.

2.2 Armstrong Steel Corp. (hereafter referred to as A.S.C.) standard specifications apply unless stipulated otherwise in the Contract Documents. A.S.C. design, fabrication, quality criteria, standards, practice, methods and tolerances shall govern the work with any other interpretations to the contrary notwithstanding. It is understood by both Parties that the BUYER/END USE CUSTOMER is responsible for clarification of inclusions or exclusions from the architectural plans and/or specifications.

2.3 In case of discrepancies between A.S.C. structural steel plans and plans for other trades, A.S.C. plans shall govern. (Section 3 AISC Code of Standard Practices, 9th Edition)

2.4 Approval of A.S.C. drawings and calculations indicates that A.S.C. has correctly interpreted and applied the Contract Documents. This approval constitutes the contractor/owners acceptance of the A.S.C. design concepts, assumptions, and loading. (Section 4 AISC Code and MBMA 3.3.3)

2.5 Once the BUYER/END USE CUSTOMER has signed A.S.C. Approval Package and the project is released for fabrication, changes shall be billed to the BUYER/END USE CUSTOMER including material, engineering and other costs. An additional fee may be charged if the project must be moved from the fabrication and shipping schedule.



PHONE: 800-345-4610

www.armstrongsteel.com

JOB NO. : 53774R1

CUSTOMER : RUVIN LERMAN

END USER : RUVIN LERMAN

END USE : GARAGE

LOCATION : 2984 BLACK CANYON RD

: CRAWFORD, CO 81415

: MONTROSE COUNTY

PH. NO. : 907-868-2828 EMAIL: RLERMAN@MTA-TELCO.COM

THIS STRUCTURE HAS BEEN DESIGNED IN ACCORDANCE WITH THE FOLLOWING AS INDICATED:

DESIGN LOADS:

Design Code / Wind Code

: IBC-12

Building Risk Category

: II - Normal

Enclosure

: Closed

Dead Load (psf)

: 2.00

Collateral Load (psf)

: 1.00

Wind Load

: 115.00

Ultimate Wind Speed, (Vult)

: C

Wind Exposure

: 0.18/-0.18

Internal Pressure Coefficient, GCpi

: 30.9/-33.5

Wall Panel Design Wind Pressure

: 30.9/-33.5

Live Load

: 20.00

Primary Framing (psf)

: 20.00

Trib. Area Reduction

: No

Secondary Framing (psf)

: 20.00

Snow Load

: 75.00

Ground Snow Load, Pg (psf)

: 59.07

Roof Snow Load, Pf (psf)

: 59.07

Sloped Roof Snow Load, Ps (psf)

: 59.07

Snow Exposure Factor, Ce

: 1.00

Snow Importance Factor, Is

: 1.00

Thermal Factor, Ct

: 1.20

Sloped Factor, Cs

: 0.94

Seismic Load

: 1.00

Seismic Importance Factor, Ie

: D

Site Class

: Ss = 0.332 : S1 = 0.085

Mapped Spectral Response Acceleration

: Sds = 0.340 : Sd1 = 0.136

Spectral Response Coefficients

: C

Seismic Design Category

: Steel System Not Specifically

Detailed For Resistance

: Rigid Frames

: Braced Frames

: Longitudinal = 5.48

: Transverse = 5.58

Total Design Base Shear, V (kips)

: Rigid Frames = 3.00

BUILDING DESCRIPTION:

Insulation

Width (ft) : 44
Length (ft) : 60

Eave Ht. at BSW (ft)

: 17.5

Eave Ht. at FSW (ft)

: 17.5

Roof Slope at BSW

: 4.0:12

Roof Slope at FSW

: 4.0:12

Bay Spacing (ft)

: 2 at 19.5, 1 at 21

COVERING AND TRIMS:

Roof Panels & Trims

Panel Type : 26 Ga. PR

Panel Color : Colony Green

Trim Colors

Gable/Eave Trim: Fern Green

Eave Gutter : Fern Green

Wall Panel & Trims

Panel Type : 26 Ga. PR

Panel Color : Light Stone

Trim Colors

Corner Trims : Fern Green

Opening Trims : Fern Green

Downspouts : Fern Green

Base Trim : Fern Green


Drawing Index

| Drawing Name | Page(s) |
|-----------------------|---------|
| Drawing Cover | --- |
| 3D Reference | 3D Ref. |
| Anchor Bolt Plan | 1 |
| Anchor Bolt Details | 2 |
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2.6 The BUYER/END USE CUSTOMER is responsible for overall project coordination. All interface, compatibility, and design considerations concerning any materials not furnished by A.S.C. and A.S.C. steel system are to be considered and coordinated by the BUYER/END USE CUSTOMER. Specific design criteria concerning this interface between materials must be furnished before release for fabrication or A.S.C. assumptions will govern (Section 4 and Commentary, AISC Code of Standard Practice, 9th Edition)

2.7 It is the responsibility of the BUYER/END USE CUSTOMER to insure that A.S.C. plans comply with the applicable requirements of any governing building authorities. The supplying of sealed engineering data and drawings for the metal building system does not imply or constitute an agreement that A.S.C. or its design engineers are acting as the engineer of record or design professional for a construction project. These drawings are sealed only to certify the design of the structural components furnished by A.S.C.

2.8 The BUYER/END USE CUSTOM

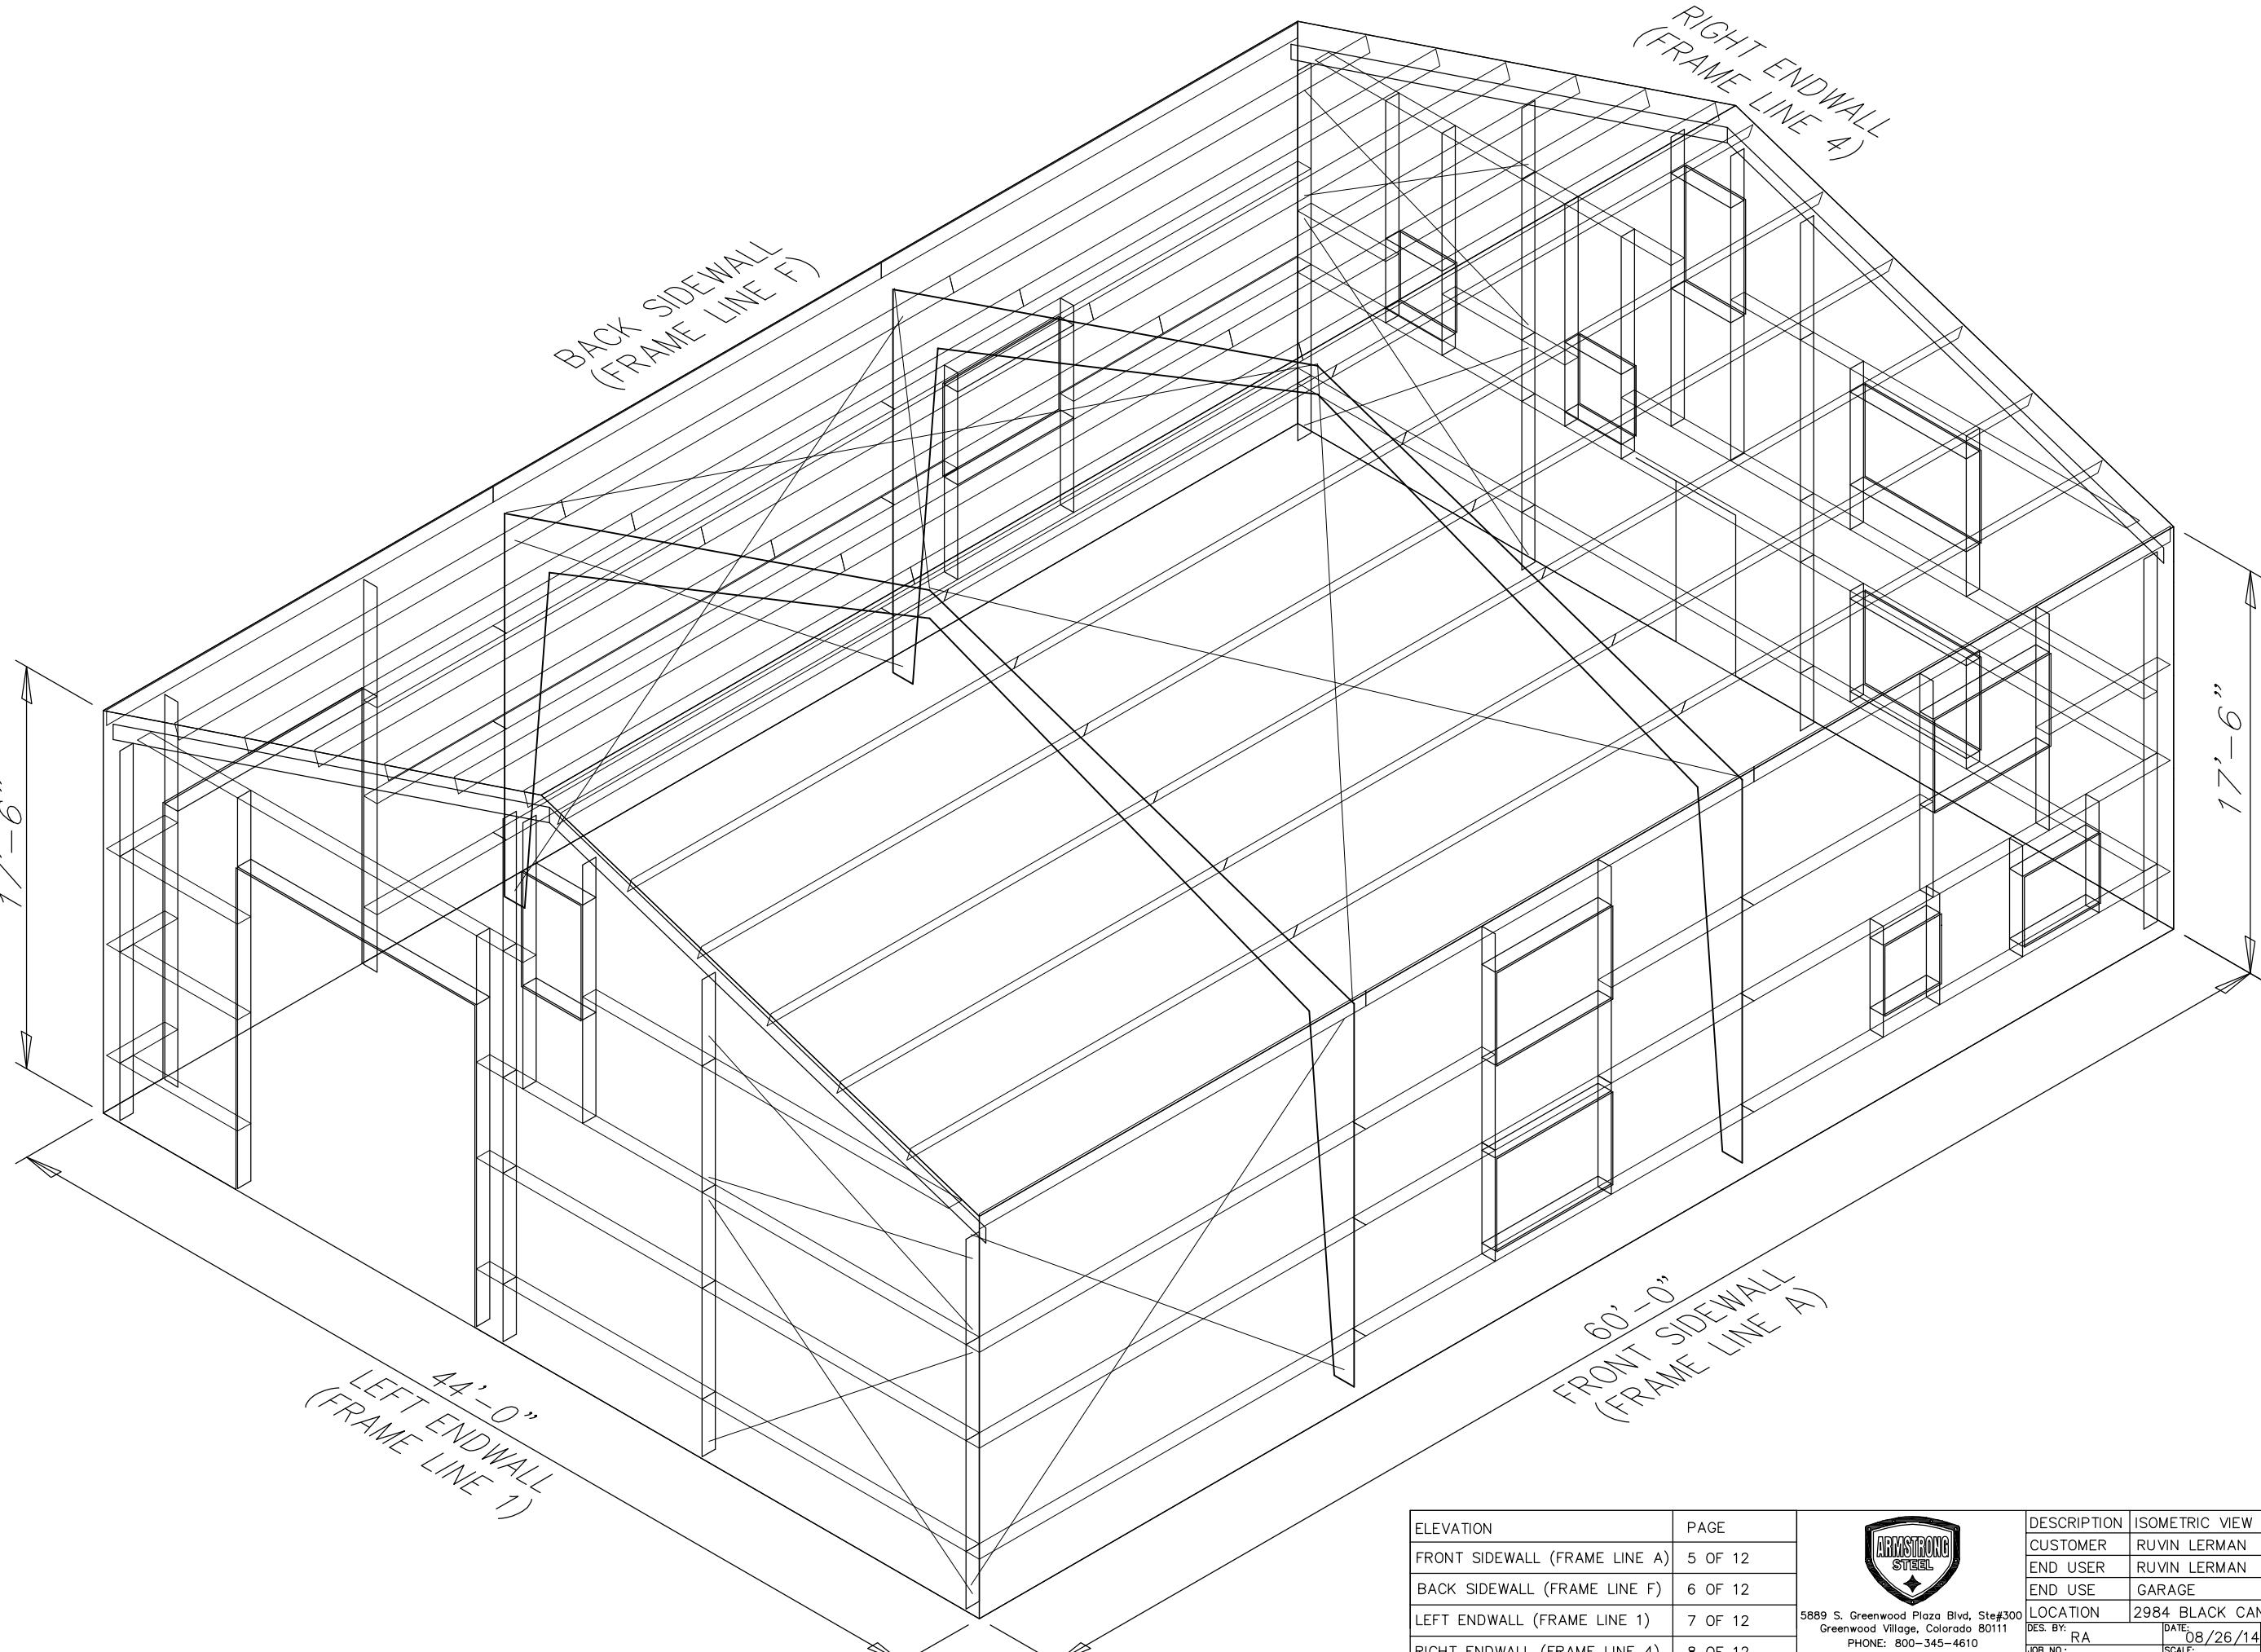


| ELEVATION | PAGE | ARMSTRONG STEEL  | DESCRIPTION | ISOMETRIC VIEW |
|-------------------------------|---------|---|-------------|--|
| FRONT SIDEWALL (FRAME LINE A) | 5 OF 12 | | CUSTOMER | RUVIN LERMAN |
| BACK SIDEWALL (FRAME LINE F) | 6 OF 12 | | END USER | RUVIN LERMAN |
| LEFT ENDWALL (FRAME LINE 1) | 7 OF 12 | | END USE | GARAGE |
| RIGHT ENDWALL (FRAME LINE 4) | 8 OF 12 | | LOCATION | 2984 BLACK CANYON RD, CRAWFORD, CO 81415 |









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PHONE: 800-345-4610
www.armstrongsteel.com

DES. BY: RA DATE: 08/26/14 ENG. BY: RA DATE: 08/26/14
JOB NO.: 53774R1 SCALE: N.T.S. DWG. NO.: 3D REFERENCE ISSUE: 0


ANCHOR BOLT SUMMARY

| | Qty | Locate | Dia (in) | Type |
|---|-----|---------|----------|------|
| ○ | 8 | Jamb | 5/8" | A307 |
| ○ | 24 | Endwall | 5/8" | |
| ⊗ | 16 | Frame | 3/4" | A307 |

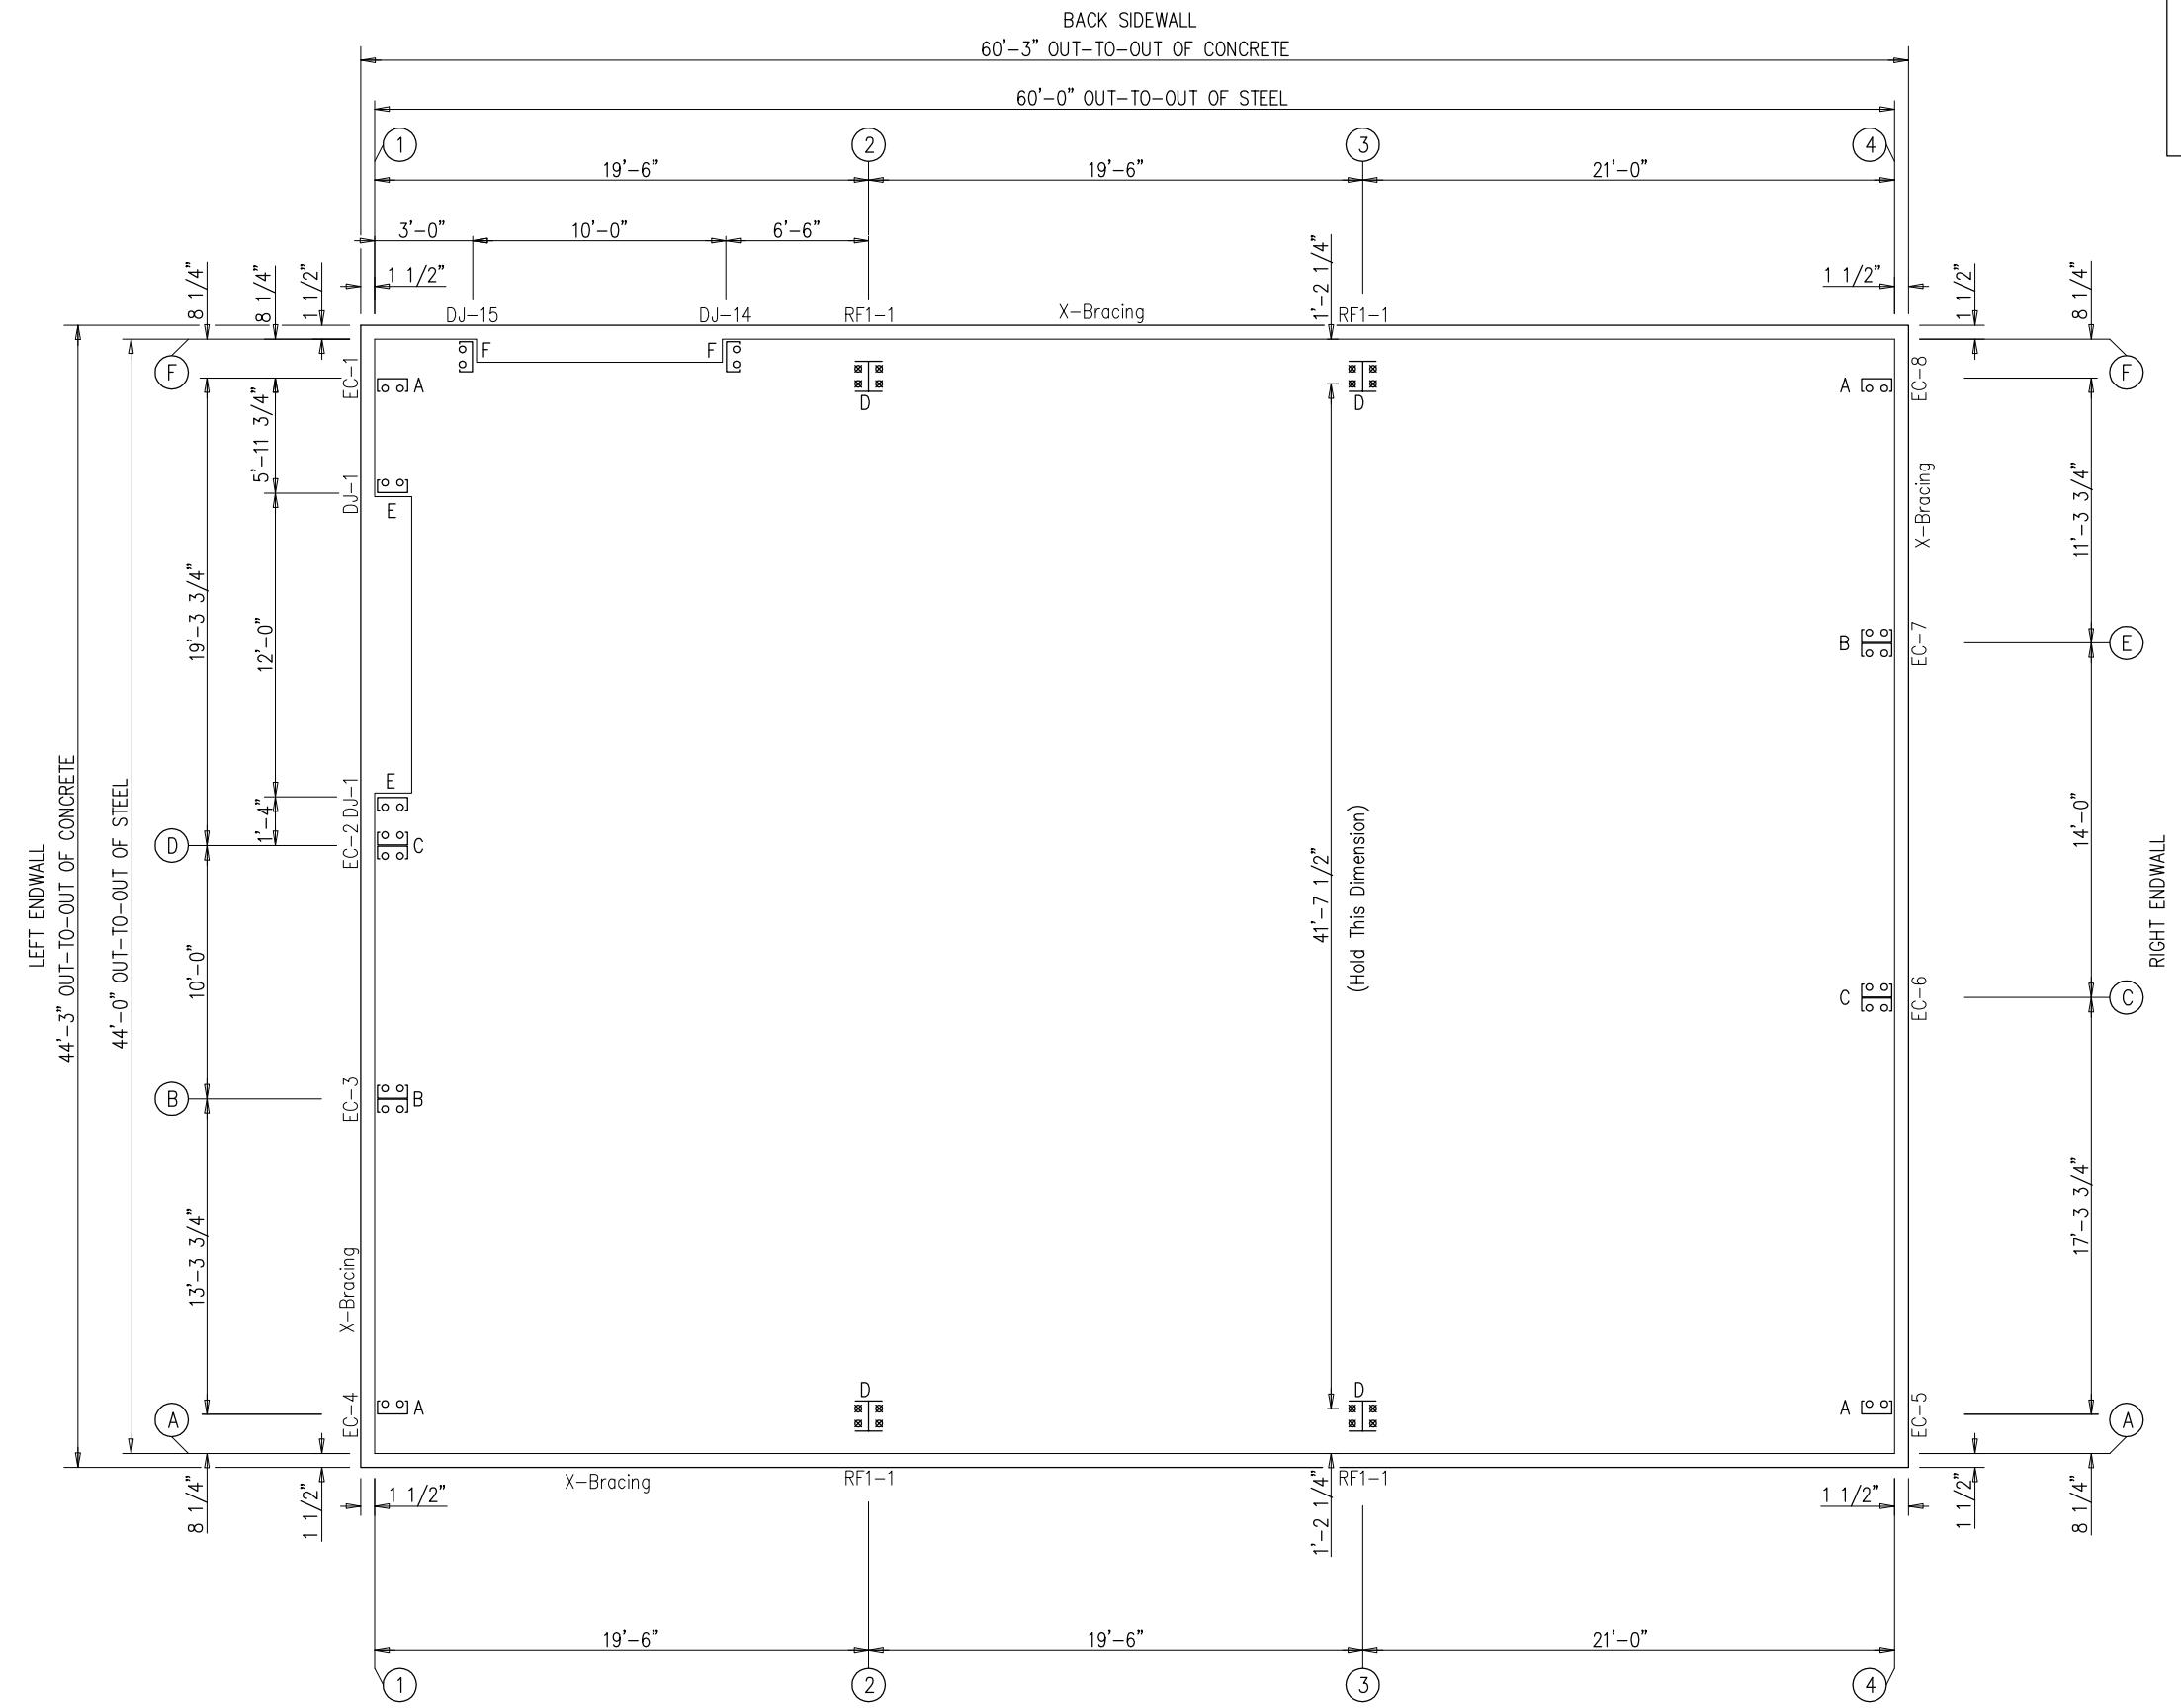

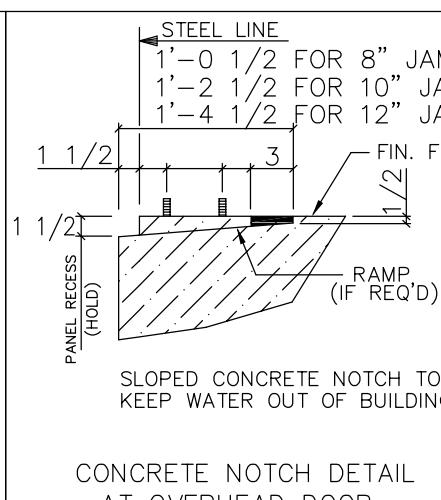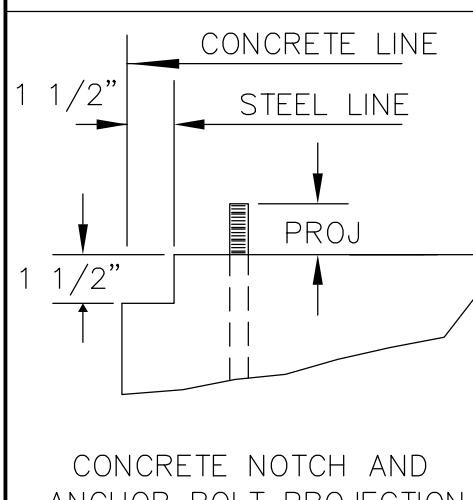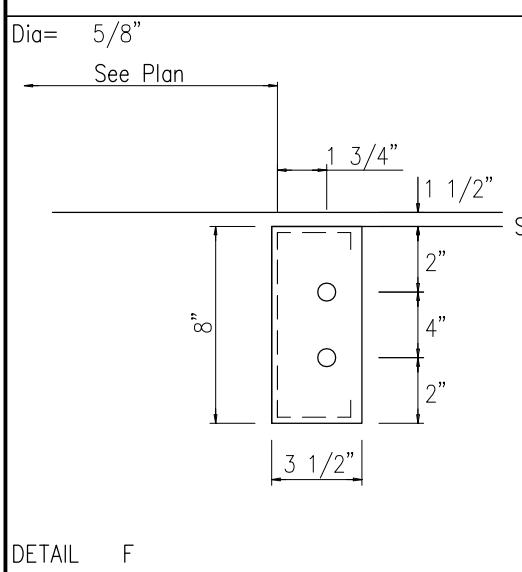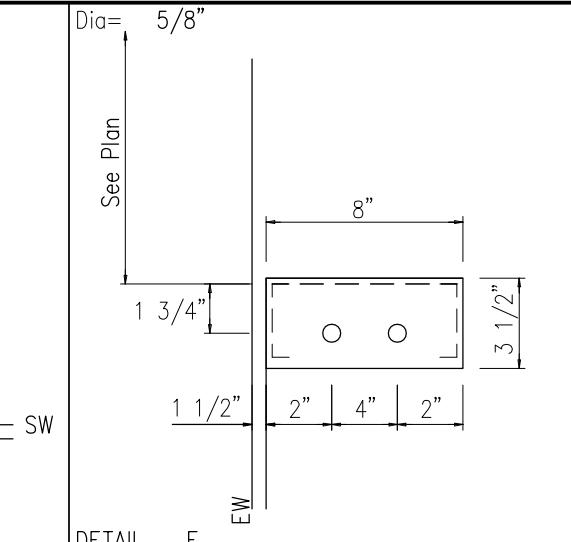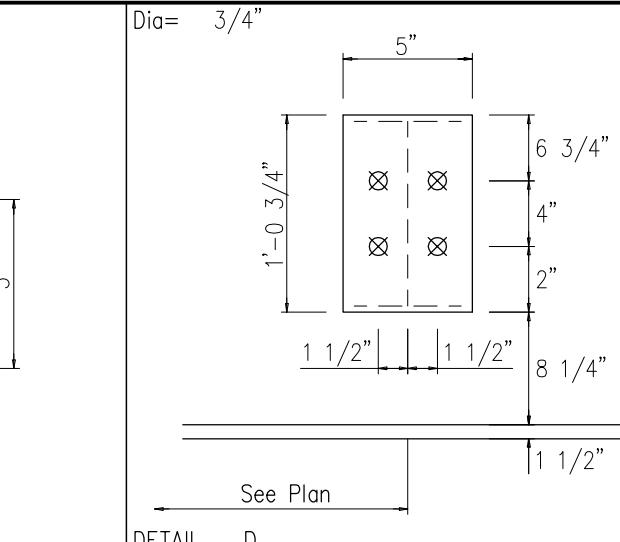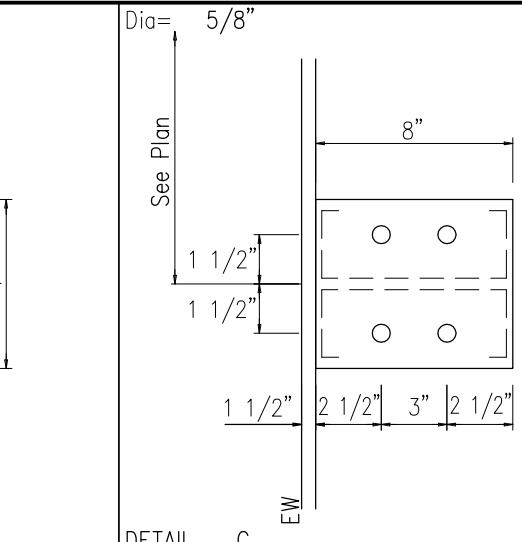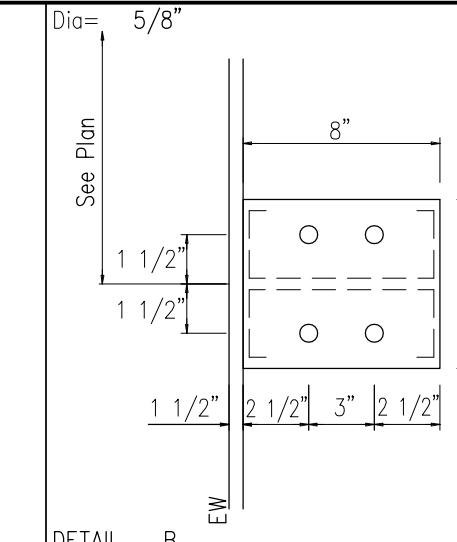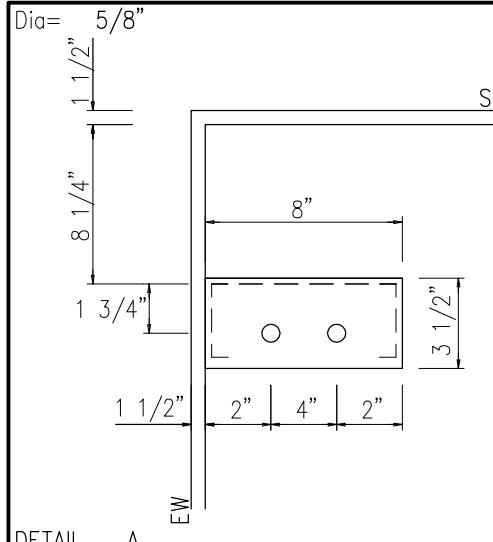


ANCHOR BOLT DIAMETERS HAVE BEEN DESIGNED BY THE METAL BUILDING MANUFACTURER BASED ON AISC METHOD WITH COMBINED SHEAR AND TENSION.
DEVELOPMENT, EMBEDMENT AND HOOK LENGTH OF ANCHOR BOLTS IN THE CONCRETE ARE DESIGN RESPONSIBILITY OF OTHERS. ALSO DESIGN OF SHEAR ANGLES, TENSION PLATES, HAIRPINS, AND ANY OTHER EMBEDDED MATERIAL IN THE CONCRETE SHALL BE DESIGNED AND PROVIDED BY OTHERS.
NOTE: ANCHOR BOLT PROJECTION IS FROM BOTTOM OF BASE PLATE.

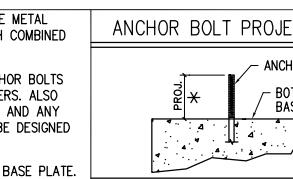


| ISSUE | DESCRIPTION | DATE | DRN. | CHK. | DES. |
|-------|------------------|----------|------|------|------|
| A | APPROVAL | 05.17.14 | CR | SRB | RA |
| A1 | REVISED APPROVAL | 06.16.14 | RHS | SRB | RA |
| P | PERMIT | 07.15.14 | CBR | RS | RA |
| P1 | REVISED PERMIT | 07.31.14 | DB | RAJ | RA |
| P2 | REVISED PERMIT | 08.29.14 | DB | TSP | RA |
| O | CONSTRUCTION | 03.11.15 | DB | SH | RA |

| DESCRIPTION | ANCHOR BOLT DETAILS |
|-------------|--|
| CUSTOMER | RUVIN LERMAN |
| END USER | RUVIN LERMAN |
| END USE | GARAGE |
| LOCATION | 2984 BLACK CANYON RD, CRAWFORD, CO 81415 |
| DES. BY: | RA |
| ENG. BY: | RA |
| DATE: | 08/26/14 |
| JOB NO.: | 53774R1 |
| SCALE: | N.T.S. |
| DWG. NO.: | 2 OF 12 |
| ISSUE: | 0 |

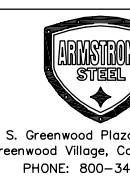

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FRAME LINES: 2 3

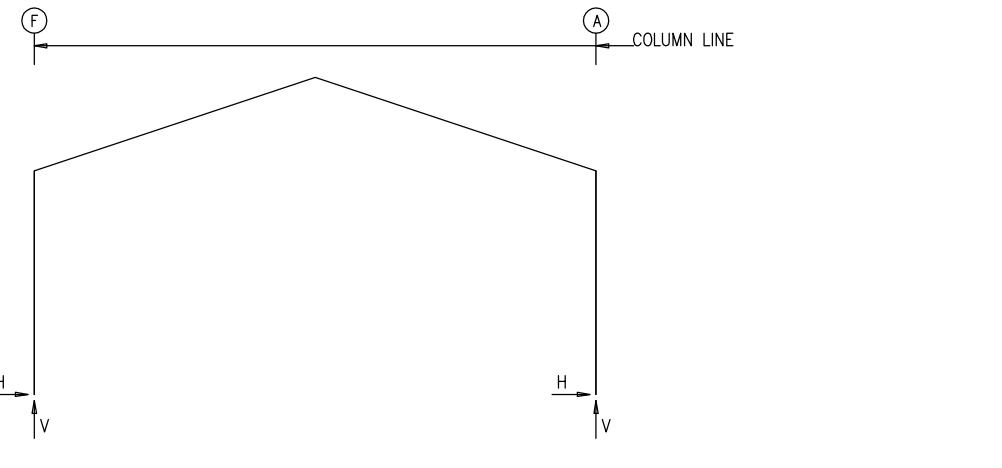

RIGID FRAME: BASIC COLUMN REACTIONS (k)

| Frame Line | Column Line | Dead | Collateral | Live | Snow | Wind_Left1 | Wind_Right1 | | | | | | |
|------------|-------------|------|------------|------|------|------------|-------------|------|------|------|-------|-----|-------|
| 2* | F | 0.5 | 1.7 | 0.2 | 0.5 | 3.4 | 8.9 | 9.9 | 26.3 | -6.3 | -10.9 | 1.5 | -6.7 |
| 2* | A | -0.5 | 1.7 | -0.2 | 0.5 | -3.4 | 8.9 | -9.9 | 26.3 | -1.5 | -6.7 | 6.3 | -10.9 |

| Frame Line | Column Line | Wind_Left2 | Wind_Right2 | Wind_Long1 | Wind_Long2 | Seismic_Left | Seismic_Right | | | | | | |
|------------|-------------|------------|-------------|------------|------------|--------------|---------------|------|-------|------|------|-----|------|
| 2* | F | -6.7 | -6.7 | 1.1 | -2.5 | 1.0 | -12.6 | -0.3 | -11.9 | -0.9 | -0.7 | 0.9 | 0.7 |
| 2* | A | -1.1 | -2.5 | 6.7 | -6.7 | 0.3 | -11.9 | -1.0 | -12.7 | -0.9 | 0.7 | 0.9 | -0.7 |

| Frame Line | Column Line | Seismic_Long | F1UNB_SL_L- | F1UNB_SL_R- | | | |
|------------|-------------|--------------|-------------|-------------|------|------|------|
| 2* | F | 0.0 | -2.2 | 8.0 | 25.1 | 8.1 | 14.8 |
| 2* | A | 0.0 | -2.2 | -8.1 | 14.8 | -8.0 | 25.1 |

2* Frame lines: 2 3

ENDWALL COLUMN: BASIC COLUMN REACTIONS (k)

| Frm Line | Col Line | Dead Vert | Collat Vert | Live Vert | Snow Vert | Wind_Left1 Vert | Wind_Right1 Vert | Wind_Left2 Vert | Wind_Right2 Vert | Wind Press | |
|----------|----------|-----------|-------------|-----------|-----------|-----------------|------------------|-----------------|------------------|------------|------|
| 1 | F | 0.4 | 0.1 | 1.7 | 4.9 | 0.0 | -2.4 | 0.0 | -2.4 | 0.0 | -2.5 |
| 1 | D | 1.0 | 0.2 | 3.8 | 11.2 | 0.0 | -5.5 | 0.0 | -2.7 | 0.0 | -2.7 |
| 1 | B | 0.6 | 0.1 | 2.1 | 6.1 | 2.2 | -5.2 | 0.0 | -0.6 | 2.2 | -5.2 |
| 1 | A | 0.3 | 0.1 | 1.2 | 3.7 | 0.0 | 2.1 | 2.2 | -5.1 | 0.0 | 2.1 |

| Frm Line | Col Line | Wind Suct | Wind Long1 | Wind Long2 | Seis Left | Seis Right | E1UNB_SL_L | E1UNB_SL_R | | | | |
|----------|----------|-----------|------------|------------|-----------|------------|------------|------------|-----|------|-----|-----|
| 1 | F | 2.3 | 0.0 | -3.1 | 0.0 | -1.7 | 0.0 | 0.1 | 0.0 | 5.1 | 0.0 | 1.4 |
| 1 | D | 4.5 | 0.0 | -5.3 | 0.0 | -3.4 | 0.0 | -0.2 | 0.0 | 0.2 | 0.0 | 5.1 |
| 1 | B | 3.3 | 0.0 | 0.1 | 1.0 | -5.8 | 1.0 | -1.7 | 0.0 | 1.4 | 0.0 | 9.7 |
| 1 | A | 1.7 | 1.0 | -3.0 | 0.0 | -0.3 | 0.0 | 1.8 | 1.0 | -1.5 | 0.0 | 3.3 |

| Frm Line | Col Line | Dead Vert | Collat Vert | Live Vert | Snow Vert | Wind_Left1 Vert | Wind_Right1 Vert | Wind_Left2 Vert | Wind_Right2 Vert | Wind Press | |
|----------|----------|-----------|-------------|-----------|-----------|-----------------|------------------|-----------------|------------------|------------|------|
| 4 | A | 0.4 | 0.1 | 1.6 | 4.7 | 0.0 | -2.5 | 0.0 | -2.2 | 0.0 | -2.5 |
| 4 | C | 1.0 | 0.2 | 4.0 | 11.9 | 0.0 | -5.6 | 0.0 | -3.1 | 0.0 | -3.1 |
| 4 | E | 0.7 | 0.1 | 2.7 | 8.1 | 2.4 | -6.8 | 0.0 | -0.5 | 2.4 | -6.8 |
| 4 | F | 0.3 | 0.1 | 1.1 | 3.1 | 0.0 | 3.1 | 2.4 | -5.6 | 0.0 | 3.1 |

| Frm Line | Col Line | Wind Suct | Wind Long1 | Wind Long2 | Seis Left | Seis Right | E2UNB_SL_L | E2UNB_SL_R | | | | |
|----------|----------|-----------|------------|------------|-----------|------------|------------|------------|-----|------|-----|------|
| 4 | A | 2.1 | 0.0 | -3.0 | 0.0 | -1.6 | 0.0 | 0.1 | 0.0 | 4.9 | 0.0 | 1.2 |
| 4 | C | 4.7 | 0.0 | -5.5 | 0.0 | -3.9 | 0.0 | -0.2 | 0.0 | 0.2 | 0.0 | 6.2 |
| 4 | E | 3.4 | 0.0 | -0.4 | 1.1 | -6.9 | 1.0 | -2.1 | 0.0 | 1.7 | 0.0 | 11.1 |
| 4 | F | 1.5 | 1.1 | -3.2 | 0.0 | 0.4 | 0.0 | 2.2 | 1.0 | -1.8 | 0.0 | 1.2 |

ENDWALL COLUMN: MAXIMUM REACTIONS, ANCHOR BOLTS, & BASE PLATES

| Frm Line | Col Line | Load ID | Hmax H | Vmax | Load ID | Hmin H | Vmin | Anc. Bolt Qty | Bolt Dia | Base_Plate (in) Width | Length | Thick | Grout (in) |
|----------|----------|---------|--------|------|---------|--------|------|---------------|----------|-----------------------|--------|-------|------------|
| 1 | F | 6 | 1.4 | -1.6 | 7 | -1.2 | -1.6 | 2 | 0.625 | 3.500 | 8.000 | 0.375 | 0.0 |
| 1 | D | 8 | 0.0 | 5.6 | 6 | 1.4 | -1.6 | 4 | 0.625 | 5.000 | 8.000 | 0.375 | 0.0 |
| 1 | B | 10 | 2.0 | -3.1 | 11 | -1.8 | -3.1 | 4 | 0.625 | 7.000 | 8.000 | 0.375 | 0.0 |
| 1 | A | 12 | 0.0 | 10.4 | 10 | 2.0 | -3.1 | 2 | 0.625 | 3.500 | 8.000 | 0.375 | 0.0 |
| 4 | A | 6 | 1.3 | -1.6 | 7 | -1.1 | -1.6 | 2 | 0.625 | 3.500 | 8.000 | 0.375 | 0.0 |
| 4 | C | 15 | 0.0 | 5.3 | 6 | 1.3 | -1.6 | 4 | 0.625 | 5.000 | 8.000 | 0.375 | 0 |

SPICE BOLT TABLE

| Mark | Qty | | | | | |
|------|-----|-----|-----|------|-------|--------|
| | Top | Bot | Int | Type | Dia | Length |
| SP-1 | 4 | 4 | 2 | A325 | 0.750 | 2.25 |
| SP-2 | 4 | 4 | 0 | A325 | 0.625 | 2.00 |


MEMBER TAB

| Mark | Web Depth | Web Plate | | Outside Flange | Inside Flange |
|-------|------------------------|----------------|----------------------|---|---|
| | Start/End | Thick | Length | W x Thk x Length | W x Thk x Length |
| RF1-1 | 12.0/27.0 | 0.188 | 17'-6 1/4" | 5 x 1/4" x 16'-9 3/16" 5 x 1/4" x 3'-1 5/16" | 5 x 1/4" x 9'-8 3/8" 5 x 5/16" x 5'-4 1/2" |
| RF1-2 | 25.0/19.2 19.2/14.0 | 0.188 0.135 | 10'-7 3/8" 10'-0" | 5 x 1/4" x 19'-10 15/16" | 5 x 5/16" x 10'-11 1/2" 5 x 1/4" x 9'-3 3/8" |

FLANGE BRACES: Both Sides(U.N.)


FBxxA(1): xx=length(in)

A = L2x2x14G

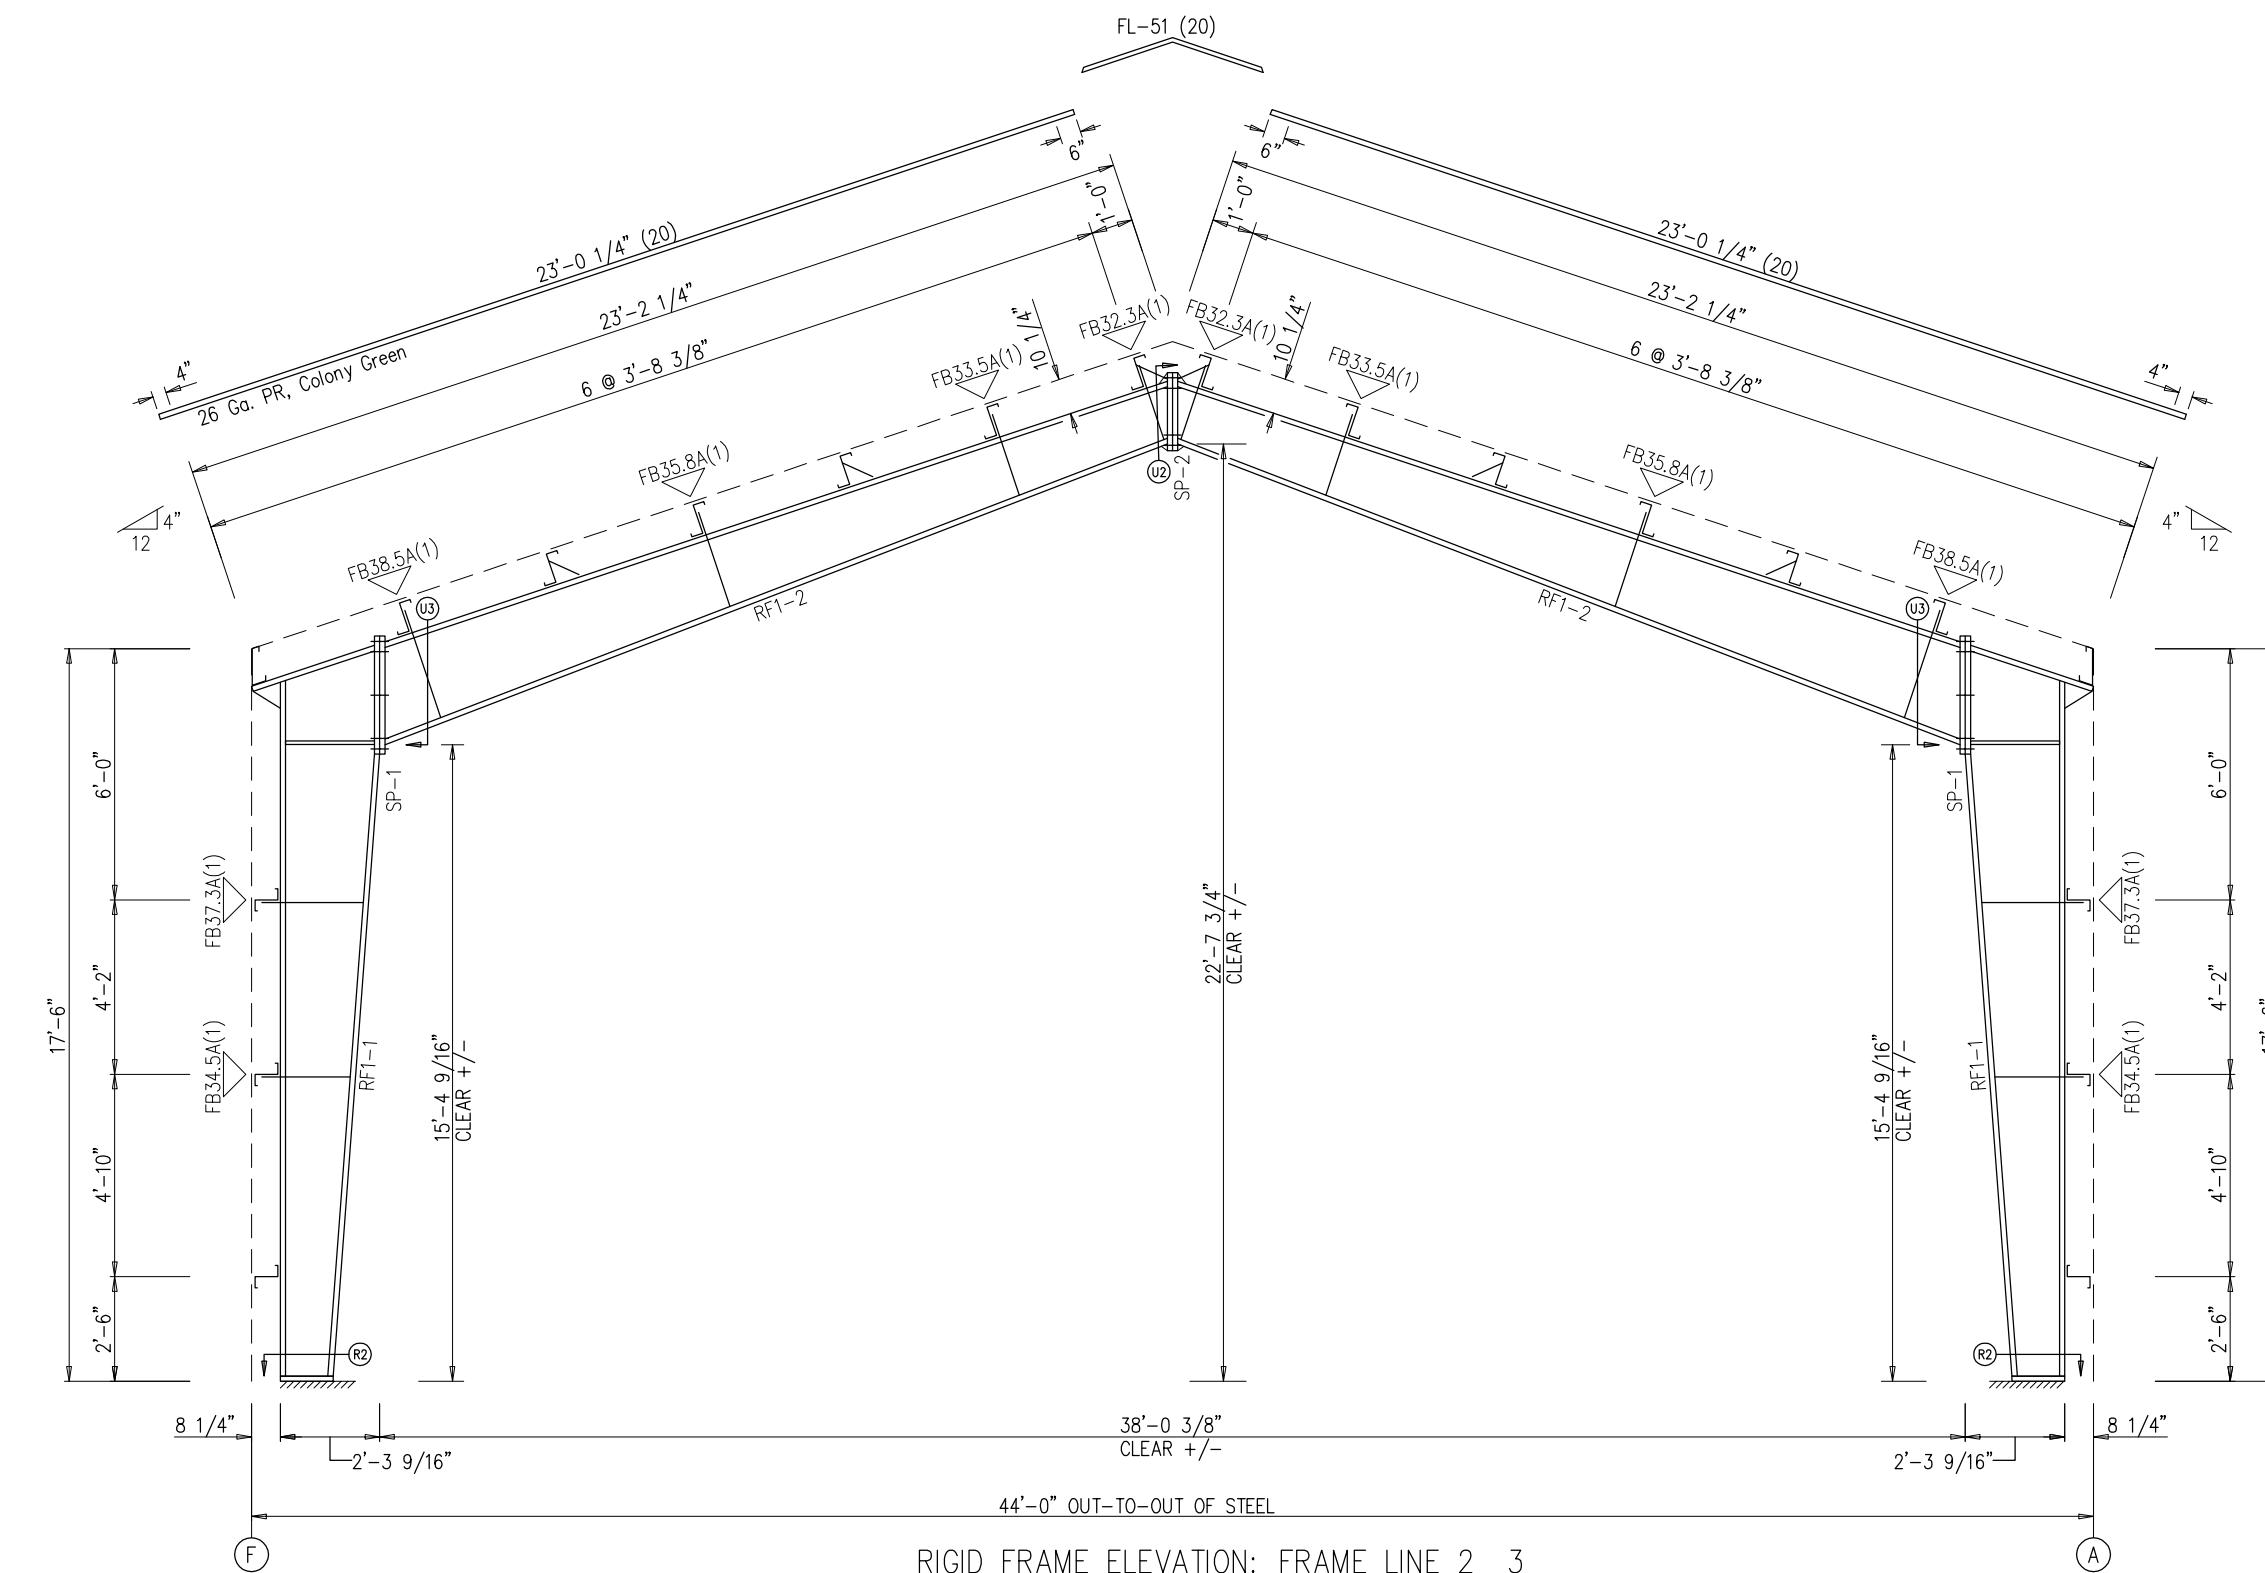


RIGID FRAME ELEVATION: FRAME LINE 2

| ISSUE | DESCRIPTION | DATE | DRN. | CHK. | DES. |  5889 S. Greenwood Plaza Blvd, Ste#300 Greenwood Village, Colorado 80111 PHONE: 800-345-4610 www.armstrongsteel.com | DESCRIPTION | RIGID FRAME ELEVATION |
|-------|------------------|----------|------|------|------|--|-------------|--|
| A | APPROVAL | 05.17.14 | CR | SRB | RA | | CUSTOMER | RUVIN LERMAN |
| A1 | REVISED APPROVAL | 06.16.14 | RHS | SRB | RA | | END USER | RUVIN LERMAN |
| P | PERMIT | 07.15.14 | CBR | RS | RA | | END USE | GARAGE |
| P1 | REVISED PERMIT | 07.31.14 | DB | RAJ | RA | | LOCATION | 2984 BLACK CANYON RD, CRAWFORD, CO 81415 |
| P2 | REVISED PERMIT | 08.29.14 | DB | TSP | RA | | DES. BY: | RA |
| O | CONSTRUCTION | 03.11.15 | DB | SH | RA | | DATE: | 08/26/14 |

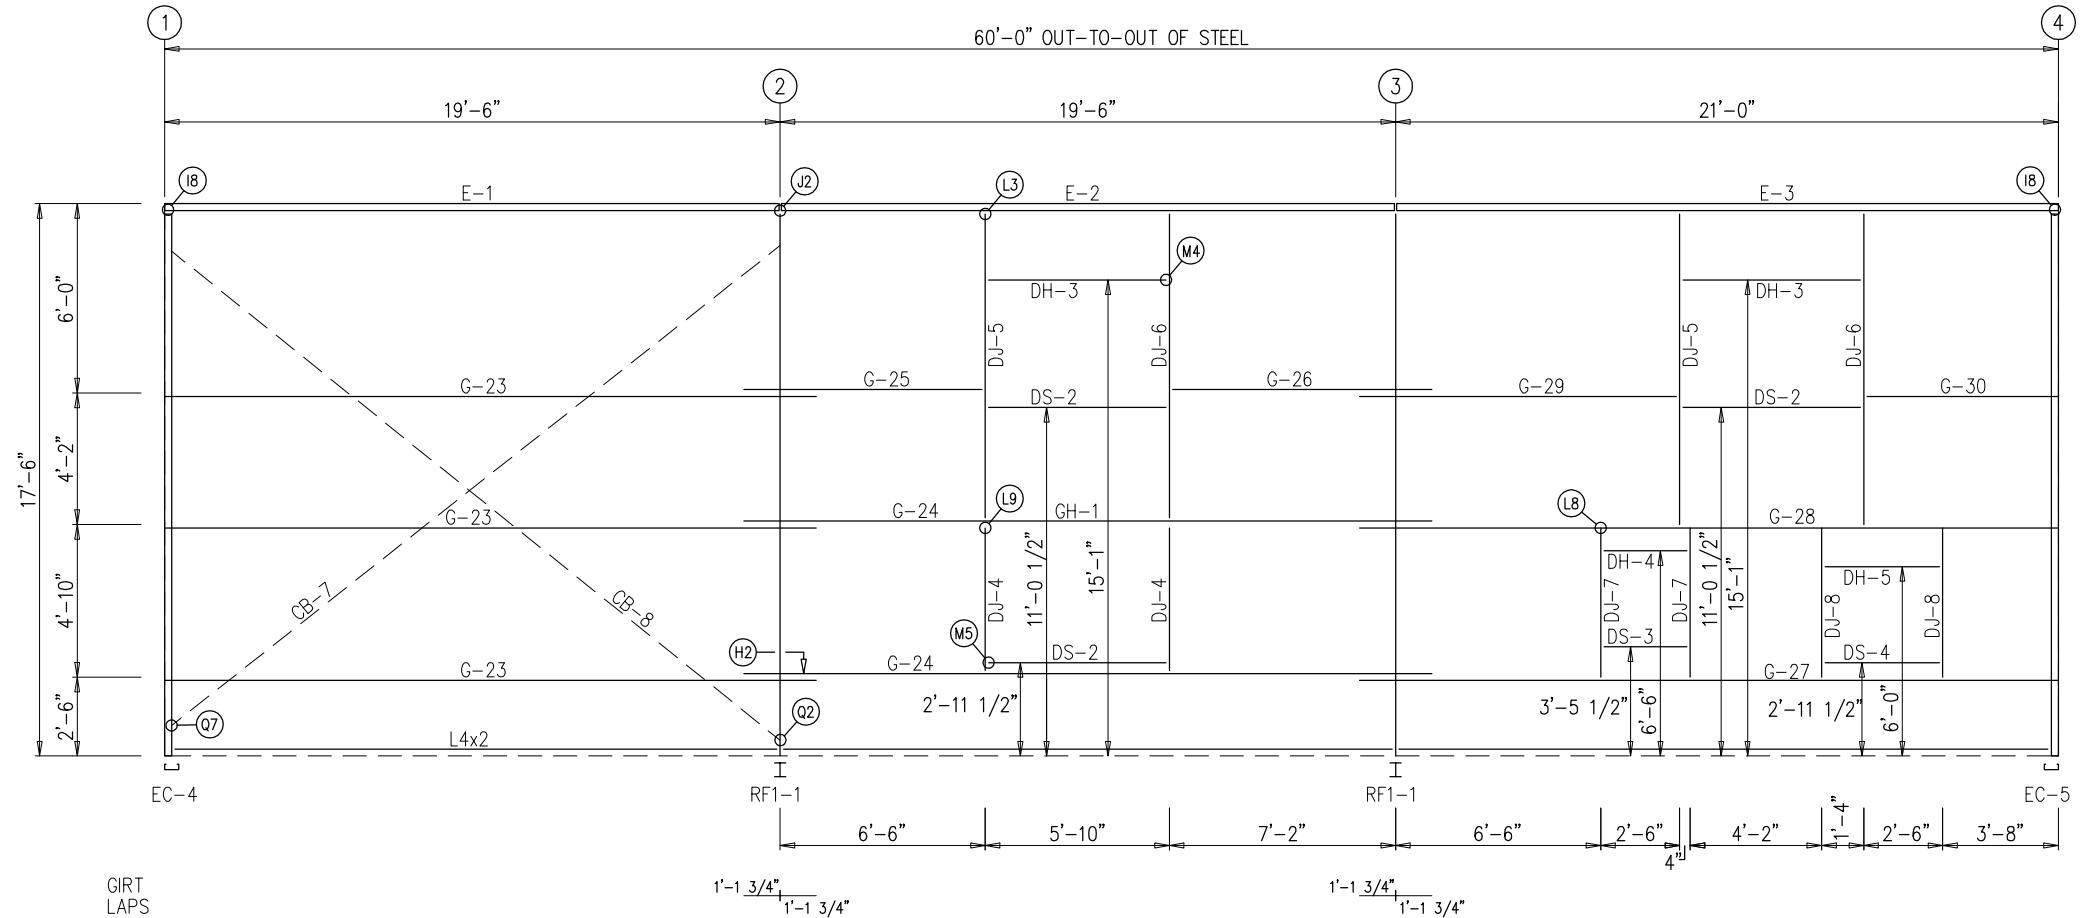

SIDEWALL FRAMING: FRAME LINE A

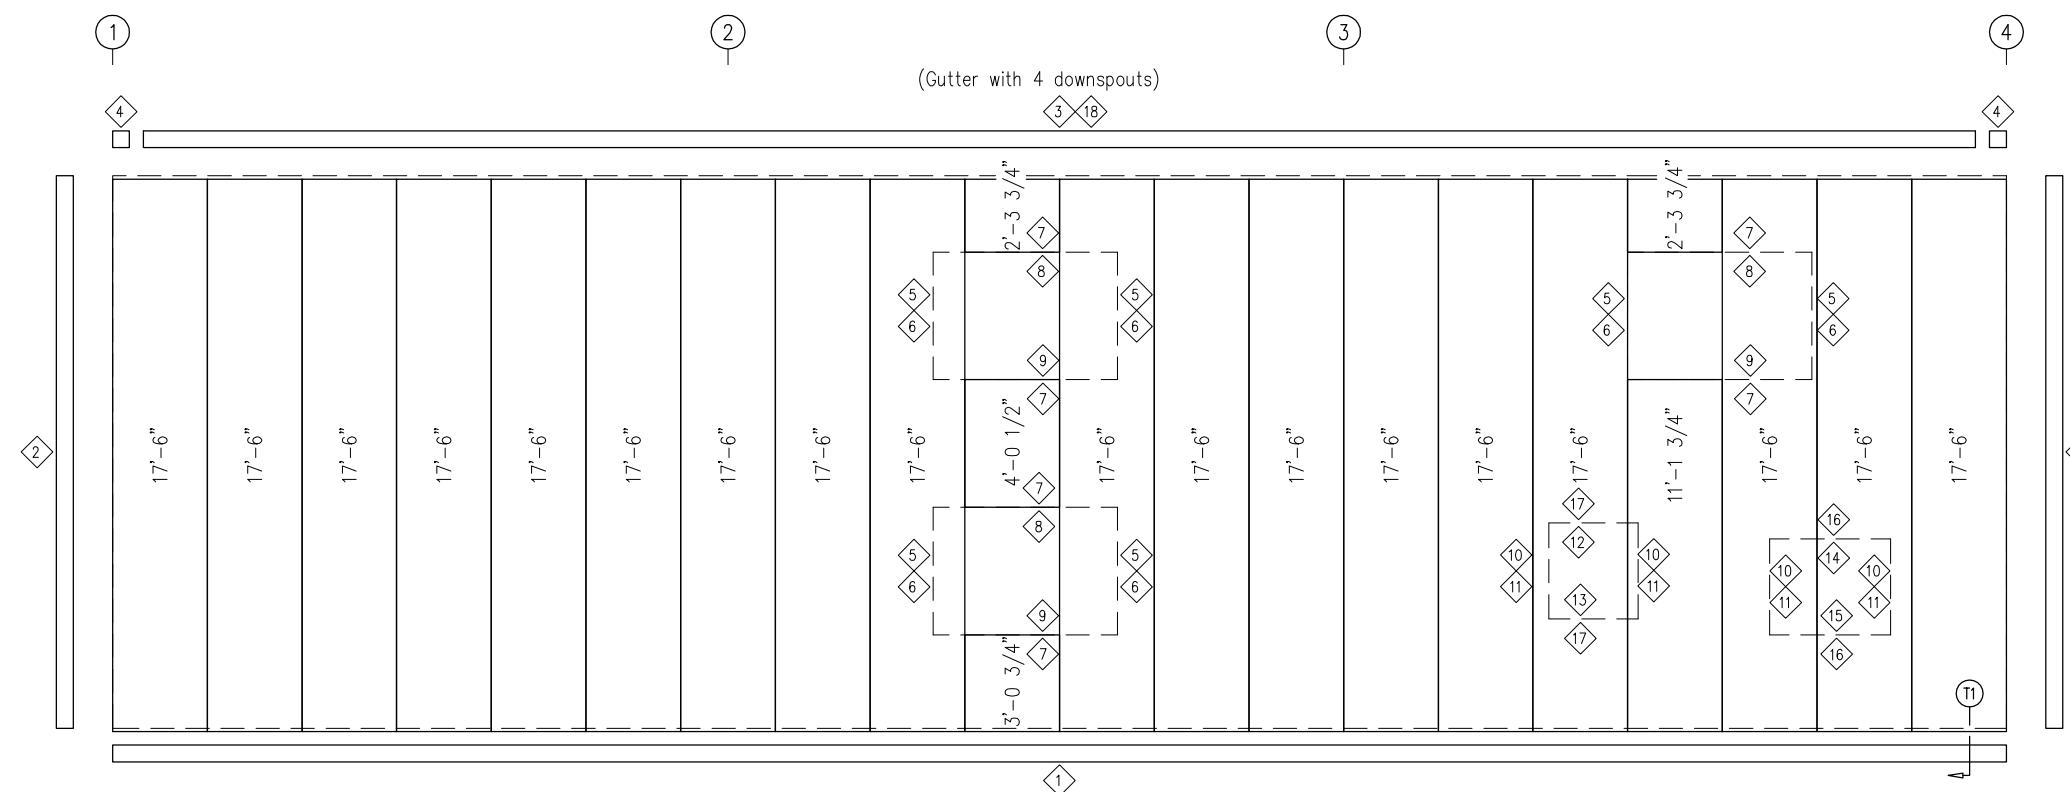

SIDEWALL SHEETING & TRIM: FRAME LINE A


PANELS: 26 Ga. PR - Light Stone

| ISSUE | DESCRIPTION | DATE | DRN. | CHK. | DES. |  5889 S. Greenwood Plaza Blvd, Ste #300 Greenwood Village, Colorado 80111 PHONE: 800-345-4610 www.armstrongsteel.com | DESCRIPTION | SIDEWALL FRAMING & SHEETING | | | | |
|-------|------------------|----------|------|------|------|---|-------------|--|--------|----------|-----------|---------|
| A | APPROVAL | 05.17.14 | CR | SRB | RA | | CUSTOMER | RUVIN LERMAN | | | | |
| A1 | REVISED APPROVAL | 06.16.14 | RHS | SRB | RA | | END USER | RUVIN LERMAN | | | | |
| P | PERMIT | 07.15.14 | CBR | RS | RA | | END USE | CARAGE | | | | |
| P1 | REVISED PERMIT | 07.31.14 | DB | RAJ | RA | | LOCATION | 2984 BLACK CANYON RD, CRAWFORD, CO 81415 | | | | |
| P2 | REVISED PERMIT | 08.29.14 | DB | TSP | RA | | DES. BY: | RA | DATE: | 08/26/14 | ENG. BY: | RA |
| O | CONSTRUCTION | 03.11.15 | DB | SH | RA | | JOB NO.: | 53774R1 | SCALE: | N.T.S. | DWG. NO.: | 5 OF 12 |
| | | | | | | | ISSUE: | O | | | | |


| TRIM TABLE FRAME LINE A | | | | |
|----------------------------|------|--------|--------|----------|
| ◇ID | QUAN | PART | LENGTH | DETAIL |
| 1 | 6 | FL-72 | 10'-2" | |
| 2 | 2 | FL-834 | 17'-6" | TRIM_25 |
| 3 | 4 | FL-18 | 15'-4" | TRIM_2 |
| 4 | 2 | FL-18A | 6" | TRIM_150 |
| 5 | 6 | FL-37 | 4'-6" | TRIM_30 |
| 6 | 6 | FL-23 | 4'-4" | TRIM_30 |
| 7 | 6 | FL-37 | 6'-4" | TRIM_30 |
| 8 | 3 | FL-851 | 6'-1" | TRIM_31 |
| 9 | 3 | FL-25 | 6'-1" | TRIM_31 |
| 10 | 4 | FL-37 | 3'-6" | TRIM_30 |
| 11 | 4 | FL-22 | 3'-4" | TRIM_30 |
| 12 | 1 | FL-850 | 3'-1" | TRIM_31 |
| 13 | 1 | FL-24 | 3'-1" | TRIM_31 |
| 14 | 1 | FL-851 | 4'-1" | TRIM_31 |
| 15 | 1 | FL-25 | 4'-1" | TRIM_31 |
| 16 | 2 | FL-37 | 4'-4" | TRIM_31 |
| 17 | 2 | FL-37 | 3'-4" | TRIM_31 |
| 18 | 4 | FL-19 | 15'-4" | TRIM_2 |

| QUAN | MARK | PART | LENGTH |
|------|------|----------|-------------|
| 2 | DJ-4 | 8X25C16 | 4'-10" |
| 2 | DJ-5 | 8X25C16 | 9'-5 7/8" |
| 2 | DJ-6 | 8X25C16 | 9'-5 7/8" |
| 2 | DJ-7 | 8X25C16 | 4'-10" |
| 2 | DJ-8 | 8X25C16 | 4'-10" |
| 2 | DH-3 | 8X25C16 | 5'-9 1/2" |
| 1 | DH-4 | 8X25C16 | 2'-9 1/2" |
| 1 | DH-5 | 8X25C16 | 3'-9 1/2" |
| 3 | DS-2 | 8X25C16 | 5'-9 1/2" |
| 1 | DS-3 | 8X25C16 | 2'-9 1/2" |
| 1 | DS-4 | 8X25C16 | 3'-9 1/2" |
| 1 | E-1 | 10ES4L14 | 19'-5 1/2" |
| 1 | E-2 | 10ES4L14 | 19'-5 1/2" |
| 1 | E-3 | 10ES4L14 | 20'-11 1/2" |
| 3 | G-23 | 8X25Z16 | 20'-7 1/2" |
| 2 | G-24 | 8X25Z16 | 21'-9 1/2" |
| 1 | G-25 | 8X25Z16 | 7'-3 3/4" |
| 1 | G-26 | 8X25Z16 | 7'-11 3/4" |
| 1 | G-27 | 8X25Z16 | 22'-1 1/2" |
| 1 | G-28 | 8X25Z14 | 22'-1 1/2" |
| 1 | G-29 | 8X25Z16 | 9'-9 3/4" |
| 1 | G-30 | 8X25Z16 | 5'-9 3/4" |
| 1 | CB-7 | HW-374 | 25'-0" |
| 1 | CB-8 | HW-374 | 24'-1 1/4" |
| 1 | GH-1 | 8X4C14 | 5'-10" |

NOTE:
FIELD CUT PANEL & DRILL 9/16"Ø HOLES FOR
FIELD LOCATED WINDOW FRAMED OPENINGS

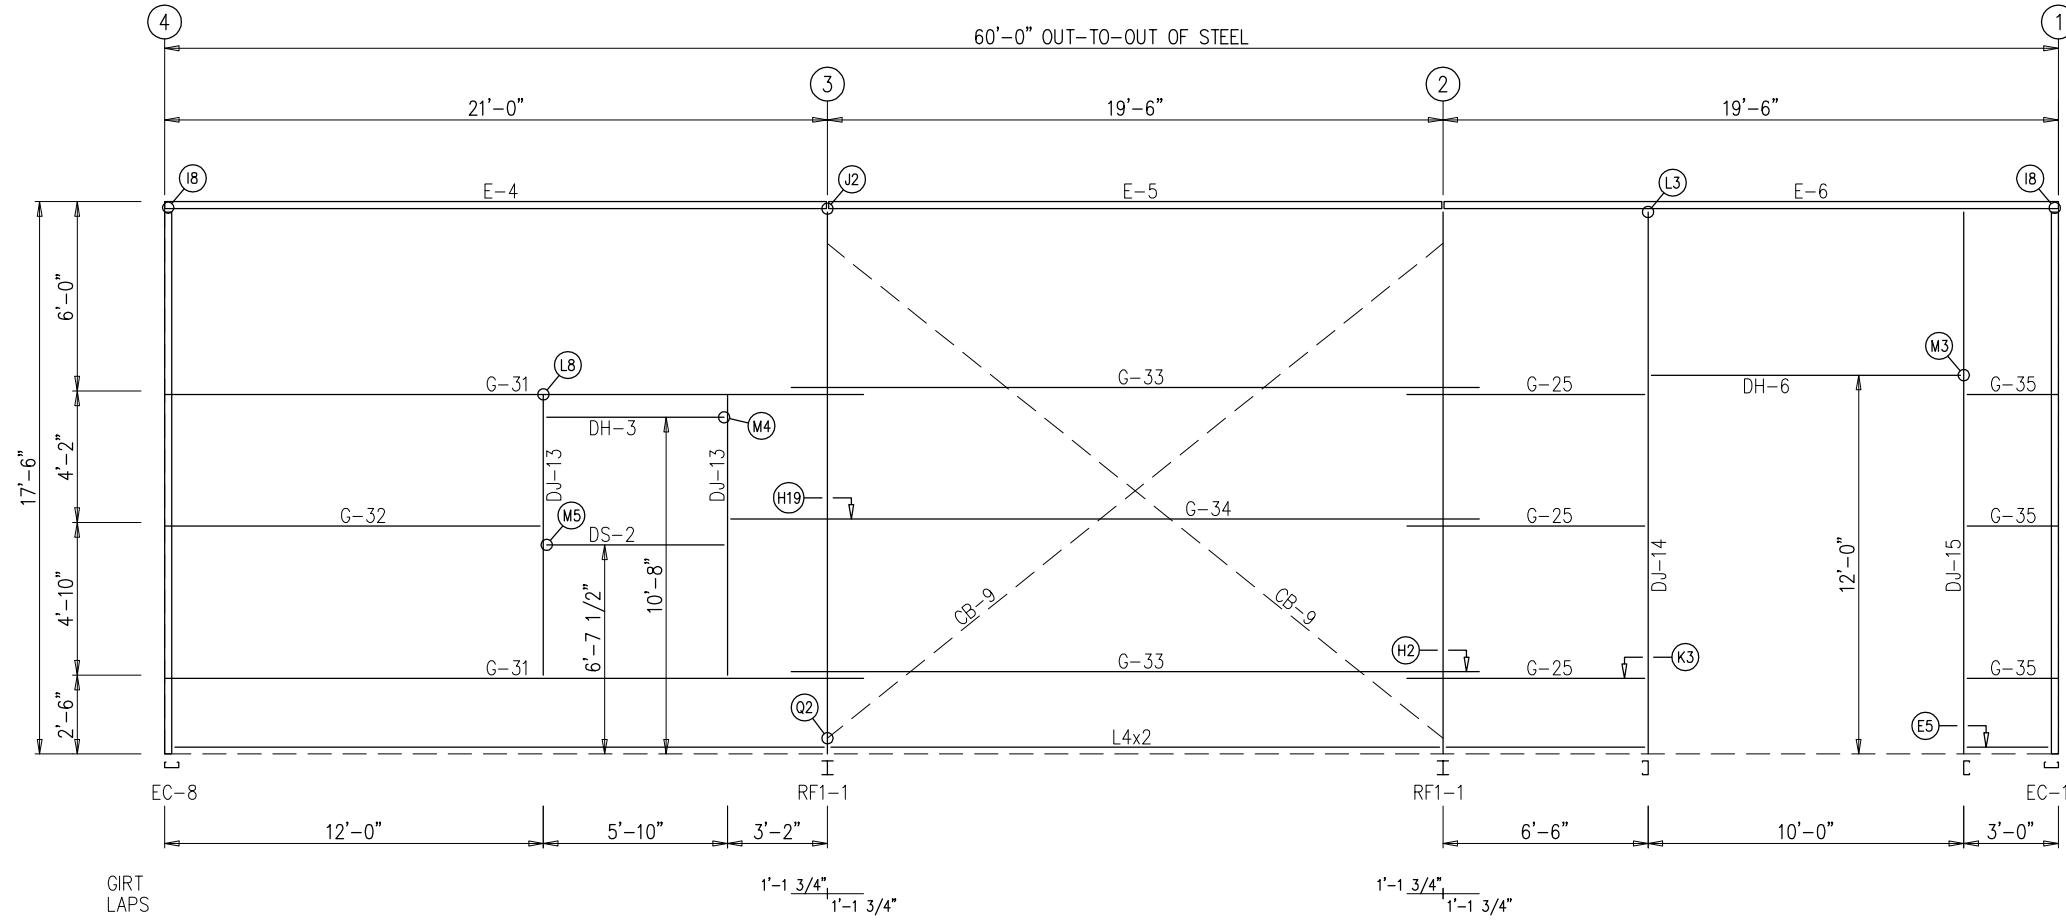

SIDEWALL FRAMING: FRAME LINE F

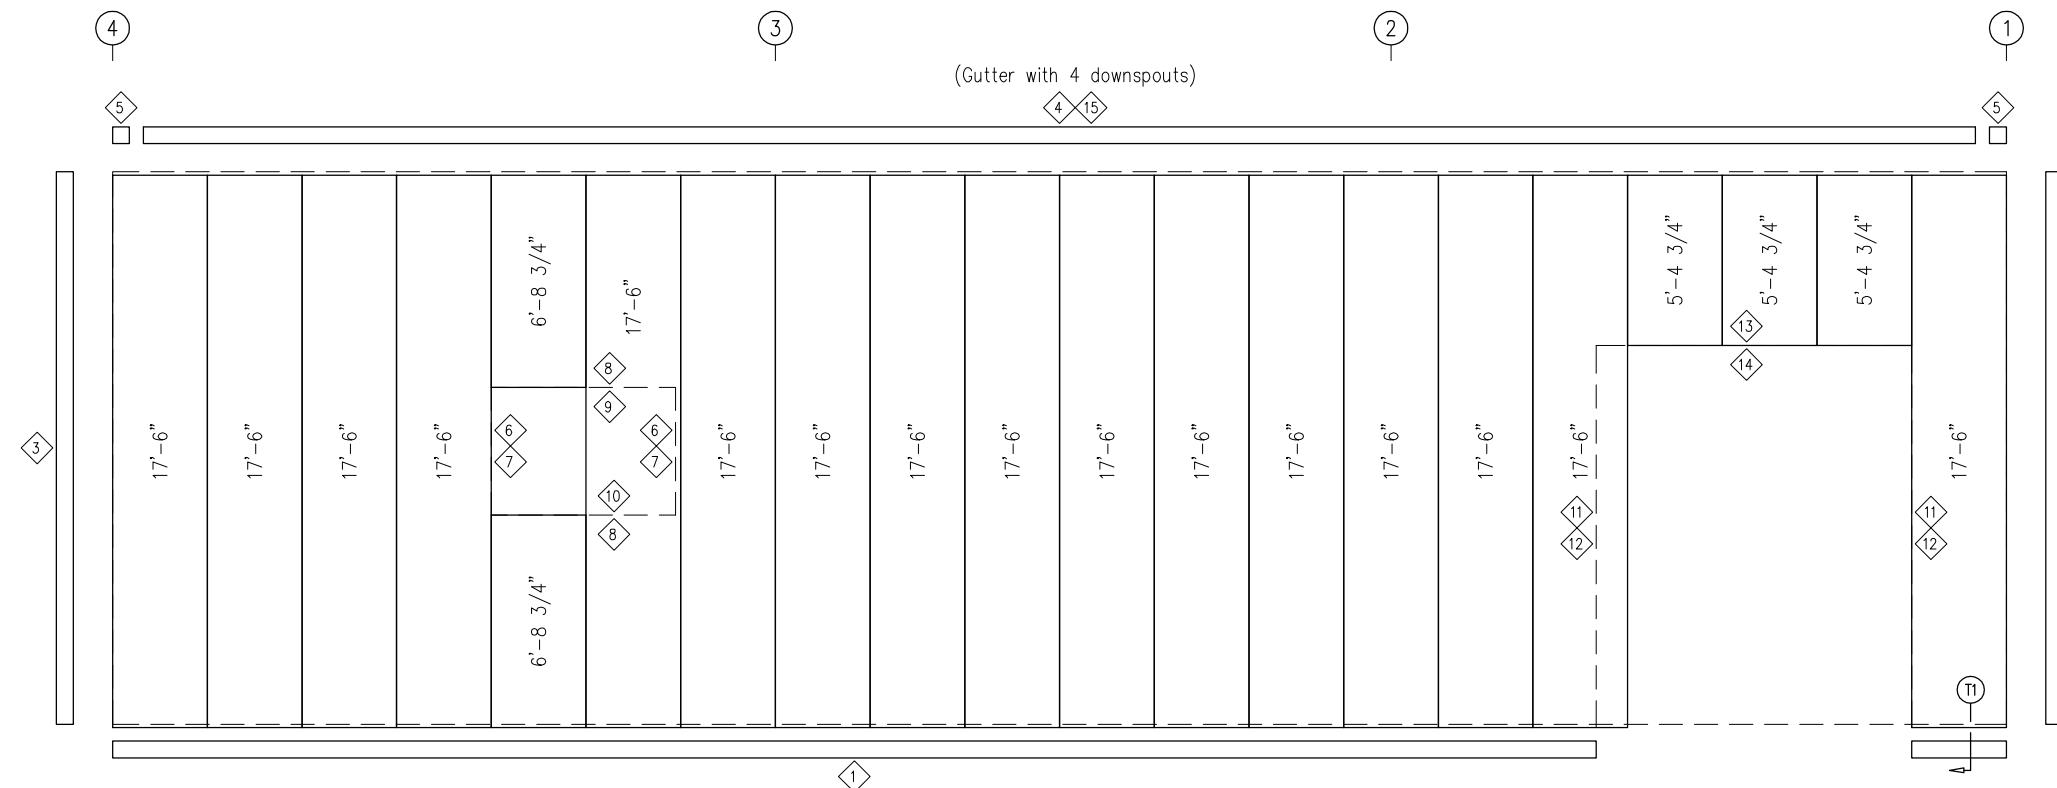


NOTE:
FIELD CUT PANEL & DRILL 9/16"Ø HOLES FOR
FIELD LOCATED WINDOW FRAMED OPENINGS.


SIDEWALL SHEETING & TRIM: FRAME LINE F

PANELS: 26 Ga. PR - Light Stone

| ISSUE | DESCRIPTION | DATE | DRN. | CHK. | DES. |  5889 S. Greenwood Plaza Blvd, Ste#300 Greenwood Village, Colorado 80111 PHONE: 800-345-4610 www.armstrongsteel.com | DESCRIPTION | SIDEWALL FRAMING & SHEETING | | | | | | |
|-------|------------------|----------|------|------|------|--|-------------|--|--------|----------|-----------|---------|--------|----------|
| A | APPROVAL | 05.17.14 | CR | SRB | RA | | CUSTOMER | RUVIN LERMAN | | | | | | |
| A1 | REVISED APPROVAL | 06.16.14 | RHS | SRB | RA | | END USER | RUVIN LERMAN | | | | | | |
| P | PERMIT | 07.15.14 | CBR | RS | RA | | END USE | GARAGE | | | | | | |
| P1 | REVISED PERMIT | 07.31.14 | DB | RAJ | RA | | LOCATION | 2984 BLACK CANYON RD, CRAWFORD, CO 81415 | | | | | | |
| P2 | REVISED PERMIT | 08.29.14 | DB | TSP | RA | | DES. BY: | RA | DATE: | 08/26/14 | ENG. BY: | RA | DATE: | 08/26/14 |
| O | CONSTRUCTION | 03.11.15 | DB | SH | RA | | JOB NO.: | 53774R1 | SCALE: | N.T.S. | DWG. NO.: | 6 OF 12 | ISSUE: | O |

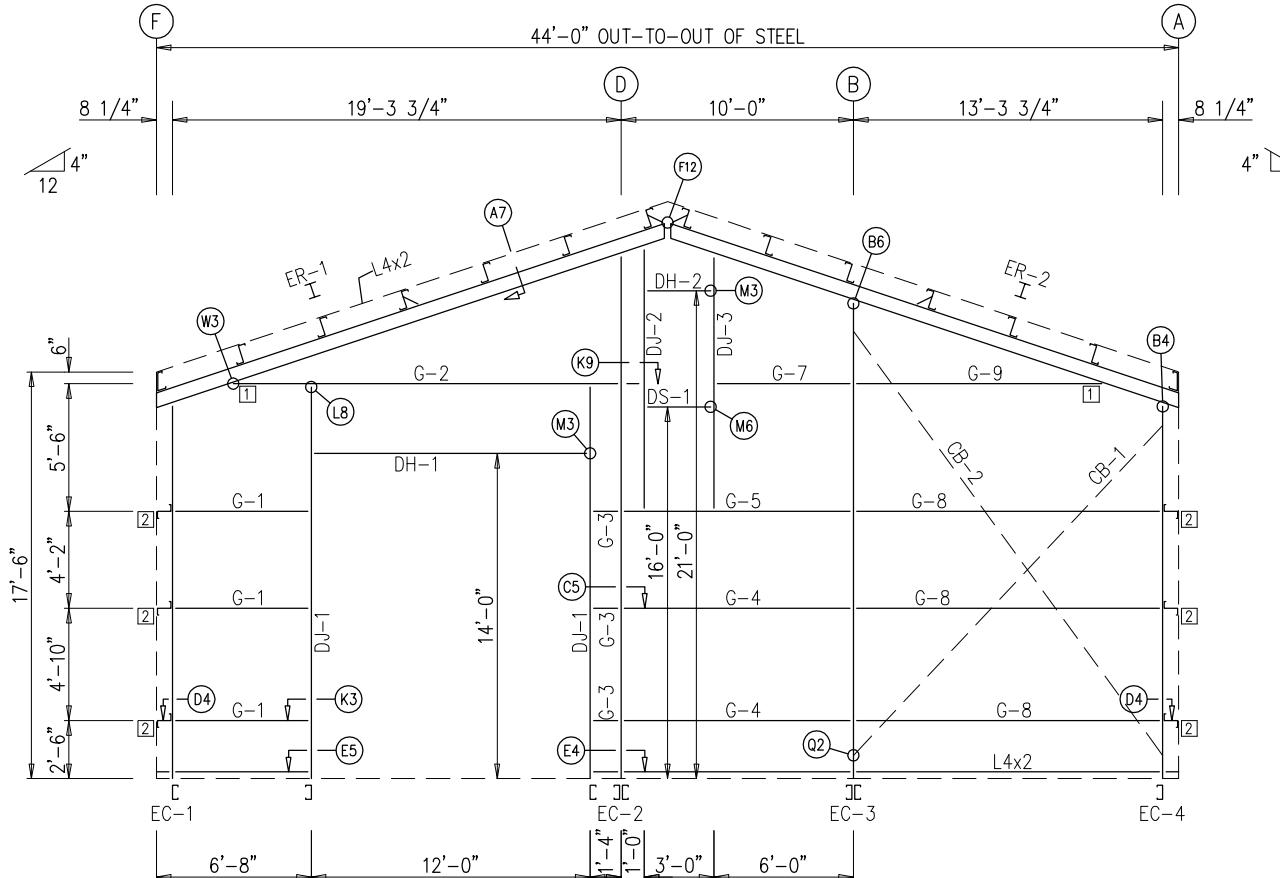

ENDWALL FRAMING: FRAME LINE 1

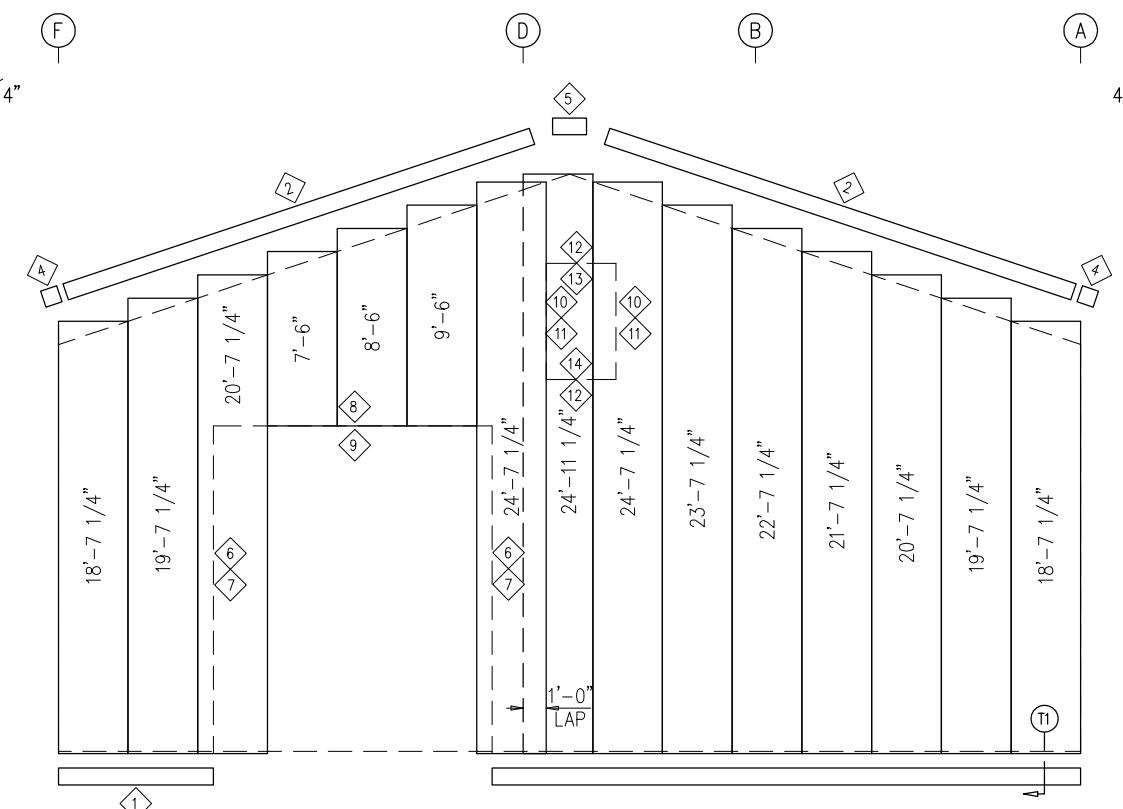

ENDWALL SHEETING & TRIM: FRAME LINE 1

PANELS: 26 Ga. PR - Light Stone

| TRIM TABLE FRAME LINE 1 | | | | |
|----------------------------|------|--------|---------|----------|
| OID | QUAN | PART | LENGTH | DETAIL |
| 1 | 4 | FL-72 | 10'-2" | TRIM_23 |
| 2 | 4 | FL-16 | 11'-10" | TRIM_150 |
| 4 | 2 | FL-16A | 6" | TRIM_106 |
| 5 | 1 | FL-16B | 1'-4" | TRIM_30 |
| 6 | 2 | FL-37 | 14'-3" | TRIM_31 |
| 7 | 2 | FL-23C | 14'-2" | TRIM_31 |
| 8 | 1 | FL-37 | 12'-6" | TRIM_31 |
| 9 | 1 | FL-853 | 12'-3" | TRIM_31 |
| 10 | 2 | FL-37 | 5'-6" | TRIM_30 |
| 11 | 2 | FL-22 | 5'-3" | TRIM_30 |
| 12 | 2 | FL-37 | 3'-6" | TRIM_31 |
| 13 | 1 | FL-850 | 3'-3" | TRIM_31 |
| 14 | 1 | FL-24 | 3'-3" | TRIM_31 |

| BOLT TABLE FRAME LINE 1 | | | | |
|----------------------------|------|------|------|--------|
| LOCATION | QUAN | TYPE | DIA | LENGTH |
| ER-1/ER-2 | 8 | A325 | 5/8" | 1 3/4" |
| Columns/Rafter | 4 | A325 | 5/8" | 1 1/2" |
| Jamb/Rafter | 2 | A325 | 5/8" | 1 1/2" |

| MEMBER TABLE FRAME LINE 1 | | | |
|------------------------------|------|---------|---------------|
| QUAN | MARK | PART | LENGTH |
| 1 | EC-1 | 8X25C12 | 15'-11 3/8" |
| 1 | EC-2 | 8X50D12 | 22'-4 5/8" |
| 1 | EC-3 | 8X70D14 | 20'-4 5/8" |
| 1 | EC-4 | 8X25C14 | 15'-11 3/8" |
| 1 | ER-1 | W8X18 | 23'-2" |
| 1 | ER-2 | W8X18 | 23'-2" |
| 2 | DJ-1 | 8X25C12 | 17'-0" |
| 1 | DJ-2 | 8X25C16 | 11'-2 5/8" |
| 1 | DJ-3 | 8X25C16 | 10'-10 5/8" |
| 1 | DH-1 | 8X25C16 | 12'-0" |
| 1 | DH-2 | 8X25C16 | 3'-0" |
| 1 | DS-1 | 8X25C16 | 3'-0" |
| 3 | G-1 | 8X25Z16 | 5'-3 9/16" |
| 1 | G-2 | 8X35Z12 | 15'-11 13/16" |
| 3 | G-3 | 8X25Z16 | 7 13/16" |
| 2 | G-4 | 8X25Z16 | 9'-4" |
| 1 | G-5 | 8X25Z16 | 9'-4" |
| 1 | G-7 | 8X25Z16 | 5'-4" |
| 3 | G-8 | 8X25Z16 | 12'-7 3/4" |
| 1 | G-9 | 8X25Z16 | 9'-11 7/8" |
| 1 | CB-1 | HW-373 | 23'-2" |
| 1 | CB-2 | HW-373 | 19'-9" |


| CONNECTION PLATES FRAME LINE 1 | | |
|-----------------------------------|------|-----------|
| ID | QUAN | MARK/PART |
| 1 | 2 | ACL-109 |
| 2 | 6 | SC-5 |

NOTE:
FIELD CUT PANEL & DRILL 9/16" HOLES FOR
FIELD LOCATED WINDOW FRAMED OPENINGS.


| ISSUE | DESCRIPTION | DATE | DRN. | CHK. | DES. | DESCRIPTION | ENDWALL FRAMING & SHEETING |
|-------|------------------|----------|------|------|------|-------------|--|
| A | APPROVAL | 05.17.14 | CR | SRB | RA | CUSTOMER | RUVIN LERMAN |
| A1 | REVISED APPROVAL | 06.16.14 | RHS | SRB | RA | END USER | RUVIN LERMAN |
| P | PERMIT | 07.15.14 | CBR | RS | RA | END USE | GARAGE |
| P1 | REVISED PERMIT | 07.31.14 | DB | RAJ | RA | LOCATION | 2984 BLACK CANYON RD, CRAWFORD, CO 81415 |
| P2 | REVISED PERMIT | 08.29.14 | DB | TSP | RA | DES. BY: | RA |
| O | CONSTRUCTION | 03.11.15 | DB | SH | RA | DATE: | 08/26/14 |
| | | | | | | ENG. BY: | RA |
| | | | | | | DATE: | 08/26/14 |
| | | | | | | JOB NO.: | 53774R1 |
| | | | | | | SCALE: | N.T.S. |
| | | | | | | DWG. NO.: | 7 OF 12 |
| | | | | | | ISSUE: | 0 |



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ENDWALL FRAMING: FRAME LINE 4

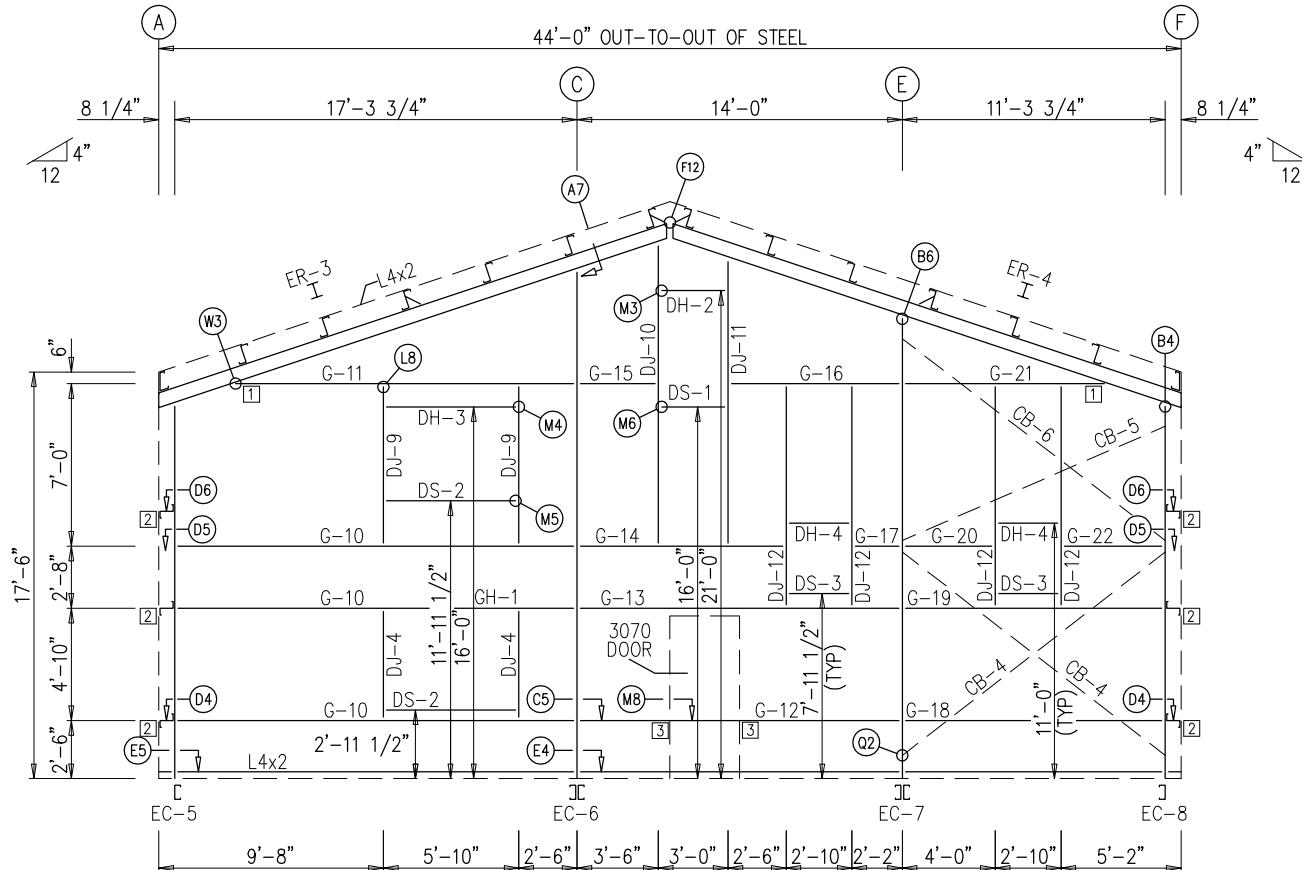

ENDWALL SHEETING & TRIM: FRAME LINE 4

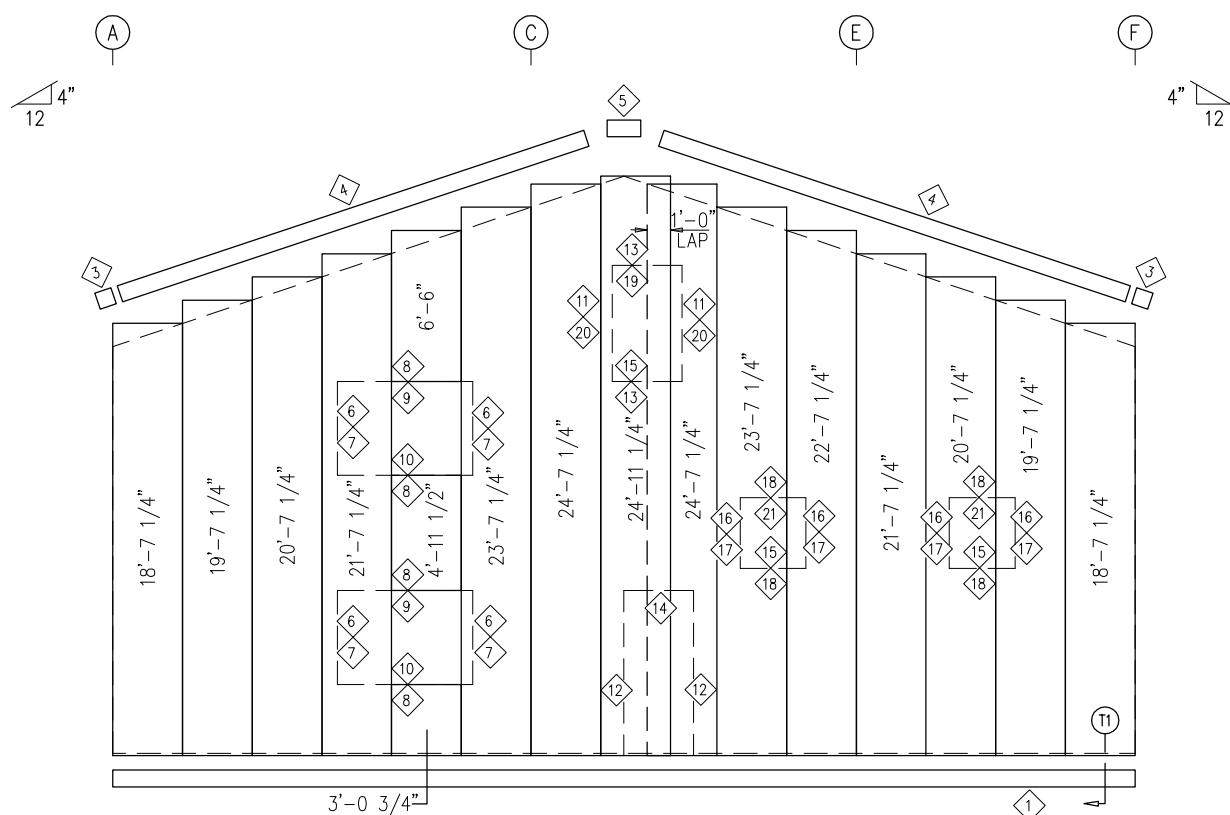PANELS: 26 Ga. PR - Light Stone

| TRIM TABLE FRAME LINE 4 | | | | |
|----------------------------|------|--------|---------|----------|
| ID | QUAN | PART | LENGTH | DETAIL |
| 1 | 4 | FL-72 | 10'-2" | |
| 3 | 2 | FL-16A | 6" | TRIM_150 |
| 4 | 4 | FL-16 | 11'-10" | TRIM_23 |
| 5 | 1 | FL-16B | 1'-4" | TRIM_106 |
| 6 | 4 | FL-37 | 4'-6" | TRIM_30 |
| 7 | 4 | FL-23 | 4'-3" | TRIM_30 |
| 8 | 4 | FL-37 | 6'-6" | TRIM_30 |
| 9 | 2 | FL-851 | 6'-3" | TRIM_31 |
| 10 | 2 | FL-25 | 6'-1" | TRIM_31 |
| 11 | 2 | FL-37 | 5'-6" | TRIM_30 |
| 12 | 2 | FL-22 | 7'-2" | TRIM_31 |
| 13 | 2 | FL-37 | 3'-6" | TRIM_31 |
| 14 | 1 | FL-850 | 3'-3" | TRIM_30 |
| 15 | 3 | FL-24 | 3'-3" | TRIM_31 |
| 16 | 4 | FL-37 | 3'-6" | TRIM_30 |
| 17 | 4 | FL-22 | 3'-3" | TRIM_30 |
| 18 | 4 | FL-37 | 3'-6" | TRIM_31 |
| 19 | 1 | FL-24 | 3'-3" | TRIM_31 |
| 20 | 2 | FL-25 | 5'-3" | TRIM_31 |
| 21 | 2 | FL-850 | 3'-3" | TRIM_30 |

| BOLT TABLE FRAME LINE 4 | | | | |
|----------------------------|------|------|------|--------|
| LOCATION | QUAN | TYPE | DIA | LENGTH |
| ER-3/ER-4 | 8 | A325 | 5/8" | 1 3/4" |
| Columns/Rafter | 4 | A325 | 5/8" | 1 1/2" |
| Jamb/Rafter | 2 | A325 | 5/8" | 1 1/2" |


| CONNECTION PLATES FRAME LINE 4 | | |
|-----------------------------------|------|-----------|
| ID | QUAN | MARK/PART |
| 1 | 2 | ACL-109 |
| 2 | 6 | SC-5 |
| 3 | 2 | CL-8 |

| MEMBER TABLE FRAME LINE 4 | | | | |
|------------------------------|-------|---------|---------------|--|
| QUAN | MARK | PART | LENGTH | |
| 1 | EC-5 | 8X35C14 | 15'-11 3/8" | |
| 1 | EC-6 | 8X50D12 | 21'-8 5/8" | |
| 1 | EC-7 | 8X70D14 | 19'-8 5/8" | |
| 1 | EC-8 | 8X25C14 | 15'-11 3/8" | |
| 1 | ER-3 | W8X18 | 23'-2" | |
| 1 | ER-4 | W8X18 | 23'-2" | |
| 2 | DJ-4 | 8X25C16 | 4'-10" | |
| 2 | DJ-9 | 8X25C16 | 7'-0" | |
| 1 | DJ-10 | 8X25C16 | 12'-10 5/8" | |
| 1 | DJ-11 | 8X25C16 | 12'-2 5/8" | |
| 4 | DJ-12 | 8X25C16 | 9'-8" | |
| 1 | DH-2 | 8X25C16 | 3'-0" | |
| 1 | DH-3 | 8X25C16 | 5'-9 1/2" | |
| 2 | DH-4 | 8X25C16 | 2'-9 1/2" | |
| 1 | DS-1 | 8X25C16 | 3'-0" | |
| 2 | DS-2 | 8X25C16 | 5'-9 1/2" | |
| 2 | DS-3 | 8X25C16 | 2'-9 1/2" | |
| 3 | G-10 | 8X25Z16 | 16'-7 5/8" | |
| 1 | G-11 | 8X35Z16 | 13'-11 13/16" | |
| 1 | G-12 | 8X25Z16 | 13'-3 7/8" | |
| 1 | G-13 | 8X25Z16 | 13'-3 7/8" | |
| 1 | G-14 | 8X25Z16 | 8'-4" | |
| 1 | G-15 | 8X25Z16 | 2'-10" | |
| 1 | G-16 | 8X25Z16 | 6'-10" | |
| 1 | G-17 | 8X25Z16 | 1'-6" | |
| 1 | G-18 | 8X25Z16 | 10'-7 3/4" | |
| 1 | G-19 | 8X25Z16 | 10'-7 3/4" | |
| 1 | G-20 | 8X25Z16 | 3'-4" | |
| 1 | G-21 | 8X25Z16 | 7'-11 13/16" | |
| 1 | G-22 | 8X25Z16 | 3'-9 3/4" | |
| 2 | CB-4 | HW-373 | 14'-7 1/2" | |
| 1 | CB-5 | HW-373 | 12'-7 3/4" | |
| 1 | CB-6 | HW-373 | 14'-5 3/4" | |
| 1 | GH-1 | 8X4C14 | 5'-10" | |

NOTE:
FIELD CUT GIRT/PANEL & DRILL 9/16"Ø HOLES
FOR FIELD LOCATED SELF FRAMING WALK DOOR.

| ISSUE | DESCRIPTION | DATE | DRN. | CHK. | DES. | ARMSTRONG STEEL | DESCRIPTION | ENDWALL FRAMING & SHEETING |
|-------|------------------|----------|------|------|------|--------------------|-------------|--|
| A | APPROVAL | 05.17.14 | CR | SRB | RA | | CUSTOMER | RUVIN LERMAN |
| A1 | REVISED APPROVAL | 06.16.14 | RHS | SRB | RA | | END USER | RUVIN LERMAN |
| P | PERMIT | 07.15.14 | CBR | RS | RA | | END USE | GARAGE |
| P1 | REVISED PERMIT | 07.31.14 | DB | RAJ | RA | | LOCATION | 2984 BLACK CANYON RD, CRAWFORD, CO 81415 |
| P2 | REVISED PERMIT | 08.29.14 | DB | TSP | RA | | DES. BY: | RA |
| O | CONSTRUCTION | 03.11.15 | DB | SH | RA | | DATE: | 08/26/14 |
| | | | | | | | ENG. BY: | RA |
| | | | | | | | DATE: | 08/26/14 |
| | | | | | | | DES. NO.: | 53774R1 |
| | | | | | | | SCALE: | N.T.S. |
| | | | | | | | DWG. NO.: | 8 OF 12 |
| | | | | | | | ISSUE: | 0 |

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| TRIM TABLE ROOF PLAN | | | | |
|-------------------------|------|-------|--------|---------|
| ID | QUAN | PART | LENGTH | DETAIL |
| 1 | 20 | FL-51 | 3'-0" | TRIM_80 |
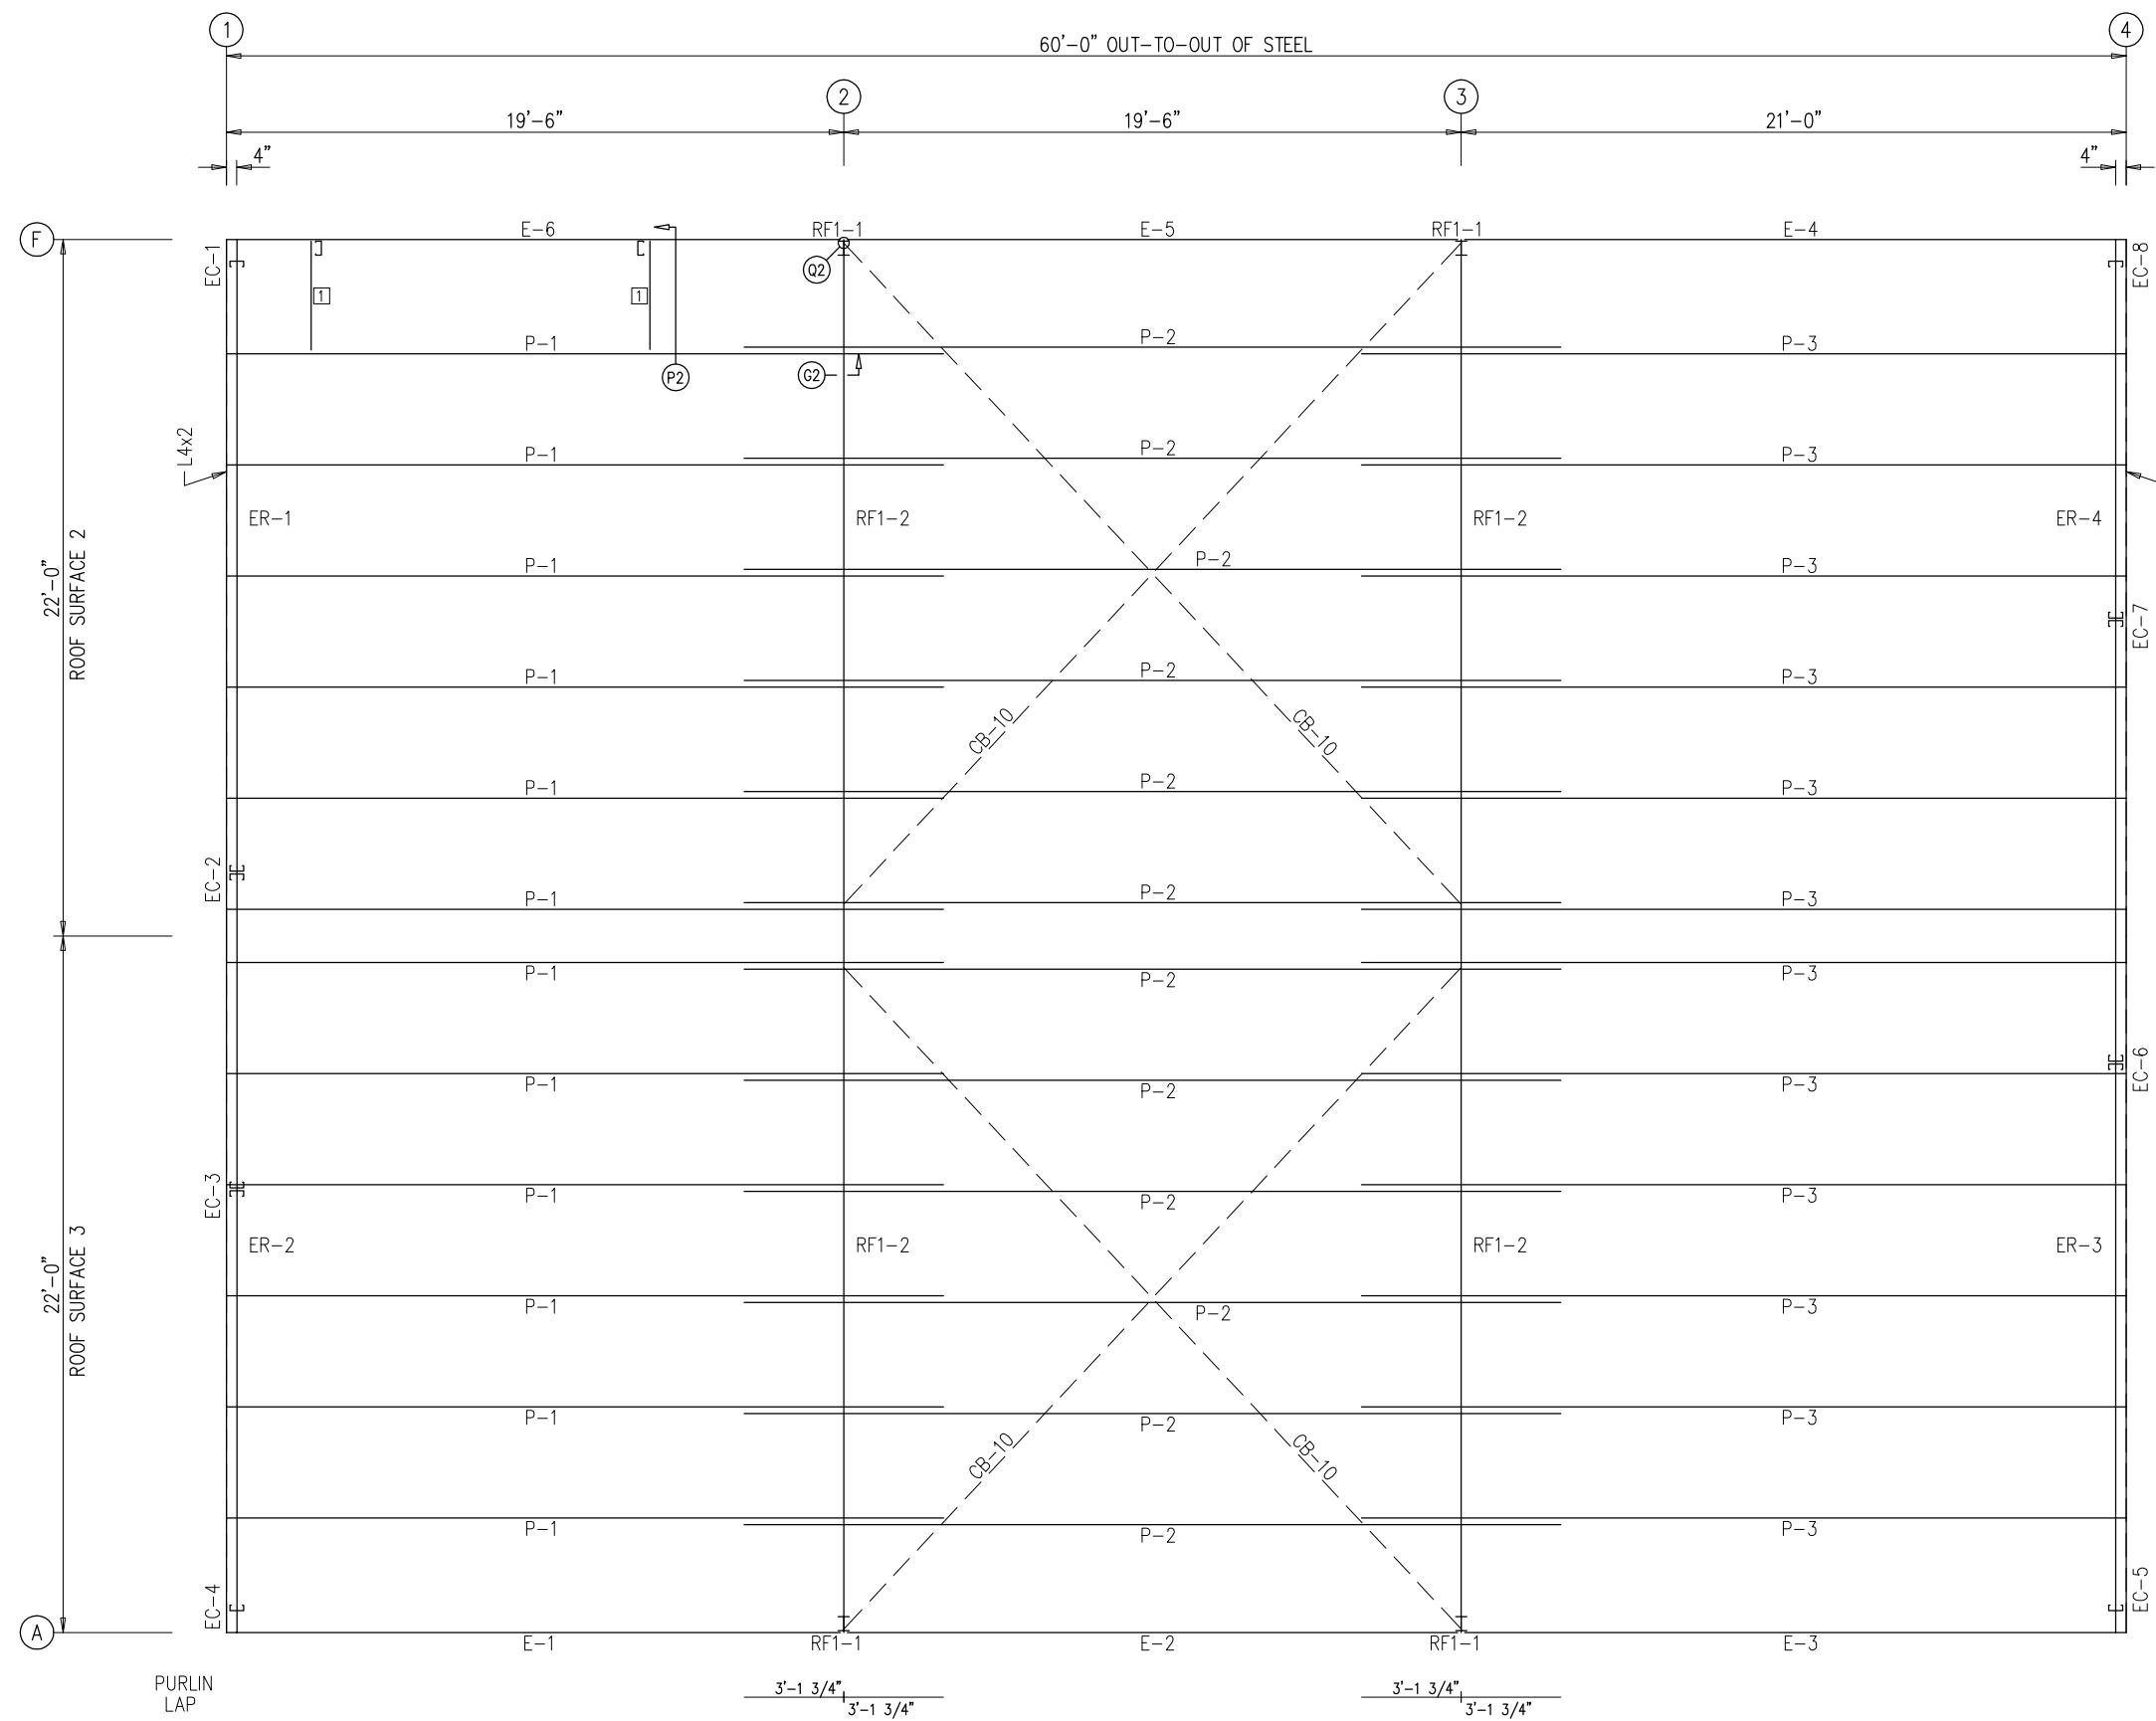
| MEMBER TABLE ROOF PLAN | | | | |
|---------------------------|-------|----------|-------------|--|
| QUAN | MARK | PART | LENGTH | |
| 12 | P-1 | 10X25Z12 | 22'-7 1/2" | |
| 12 | P-2 | 10X25Z14 | 25'-9 1/2" | |
| 12 | P-3 | 10X25Z12 | 24'-11 1/2" | |
| 1 | E-1 | 10ES4L14 | 19'-5 1/2" | |
| 1 | E-2 | 10ES4L14 | 19'-5 1/2" | |
| 1 | E-3 | 10ES4L14 | 20'-11 1/2" | |
| 1 | E-4 | 10ES4L14 | 20'-11 1/2" | |
| 1 | E-5 | 10ES4L14 | 19'-5 1/2" | |
| 1 | E-6 | 10ES4L14 | 19'-5 1/2" | |
| 4 | CB-10 | HW-373 | 28'-9" | |

| CONNECTION PLATES ROOF PLAN | | |
|--------------------------------|------|-----------|
| ID | QUAN | MARK/PART |
| 1 | 2 | JB-1 |

23'-0 1/4"
(20)

23'-0 1/4"
(20)


1
(20)

ROOF SHEETING


PANELS: 26 Ga. PR Colony Green

ROOF FRAMING PLAN


| ISSUE | DESCRIPTION | DATE | DRN. | CHK. | DES. | ARMSTRONG STEEL | DESCRIPTION | ROOF FRAMING & SHEETING |
|-------|------------------|----------|------|------|------|--------------------|-------------|--|
| A | APPROVAL | 05.17.14 | CR | SRB | RA | | CUSTOMER | RUVIN LERMAN |
| A1 | REVISED APPROVAL | 06.16.14 | RHS | SRB | RA | | END USER | RUVIN LERMAN |
| P | PERMIT | 07.15.14 | CBR | RS | RA | | END USE | GARAGE |
| P1 | REVISED PERMIT | 07.31.14 | DB | RAJ | RA | | LOCATION | 2984 BLACK CANYON RD, CRAWFORD, CO 81415 |
| P2 | REVISED PERMIT | 08.29.14 | DB | TSP | RA | | DES. BY: | RA |
| O | CONSTRUCTION | 03.11.15 | DB | SH | RA | | ENG. BY: | RA |
| | | | | | | | DATE: | 08/26/14 |
| | | | | | | | SCALE: | N.T.S. |
| | | | | | | | DWG. NO.: | 53774R1 |
| | | | | | | | ISSUE: | 9 OF 12 |

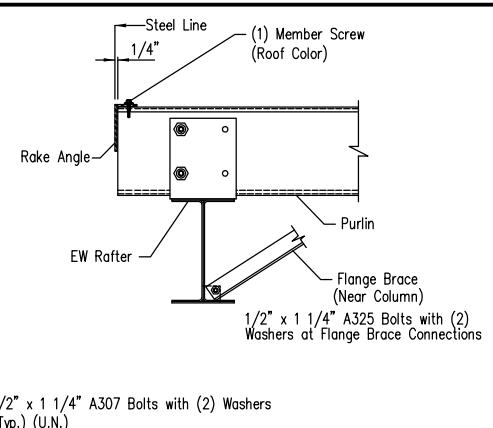


A7 SECTION THRU HOT ROLLED RAFTER

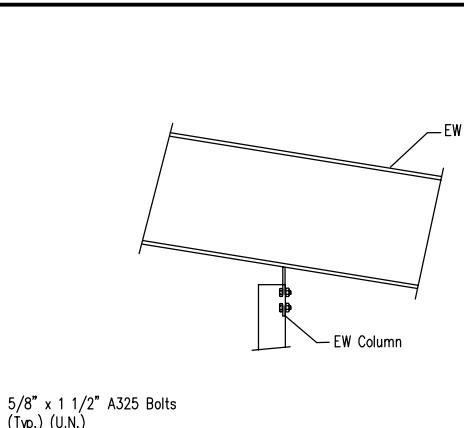


B4 ENDWALL COLUMN TO RAFTER

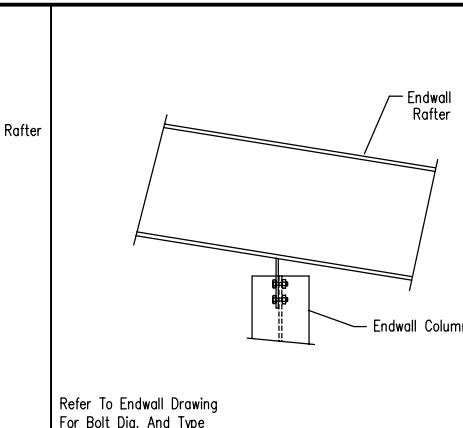


B6 HOT ROLLED ENDWALL COLUMN TO RAFTER

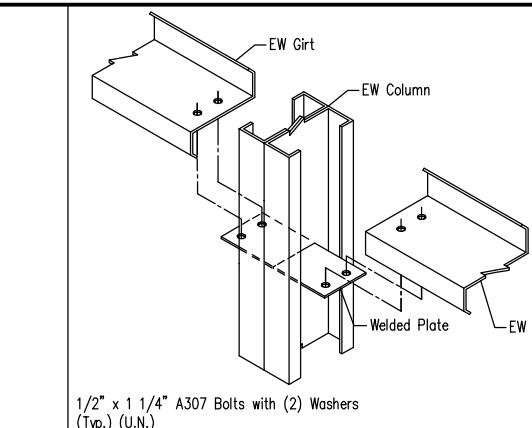


C5 DOUBLE CEE ENDWALL COLUMN TO WALL GIRT

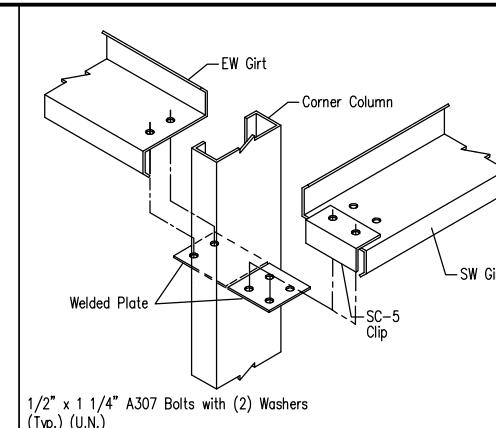


D4 CORNER COLUMN TO WALL GIRT

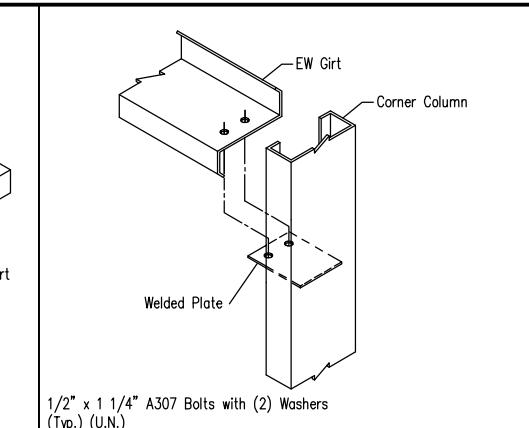


D5 CORNER COLUMN TO WALL GIRT

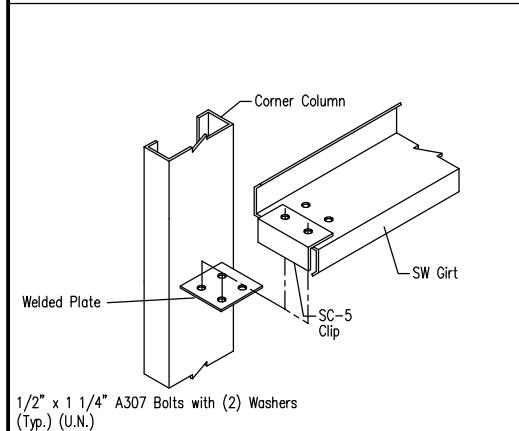


D6 CORNER COLUMN TO WALL GIRT

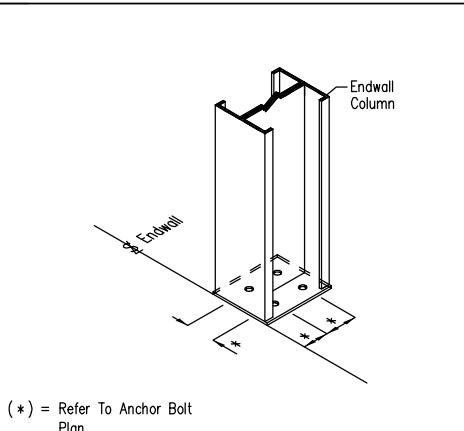


E4 BASE PLATE FOR ENDWALL COLUMN OR DOOR JAMB

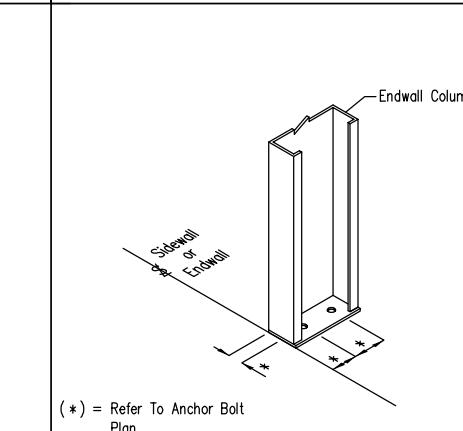


E5 BASE PLATE FOR ENDWALL COLUMN/DOOR JAMB

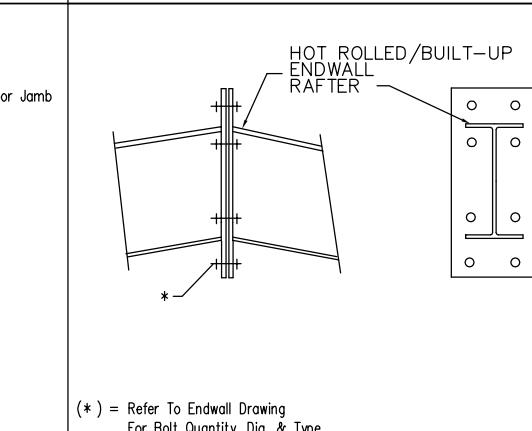


F12 Rafter Splice
At Surface Change

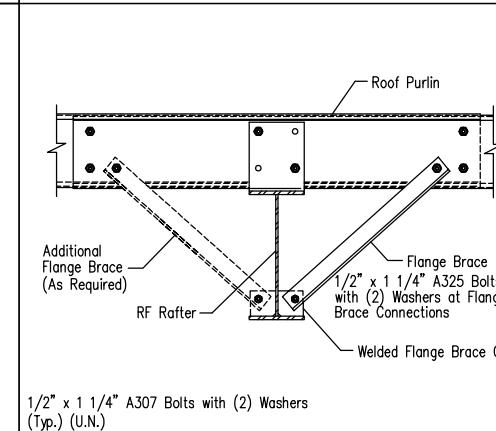


G2 ROOF PURFLIN TO INTERIOR FRAME RAFTER

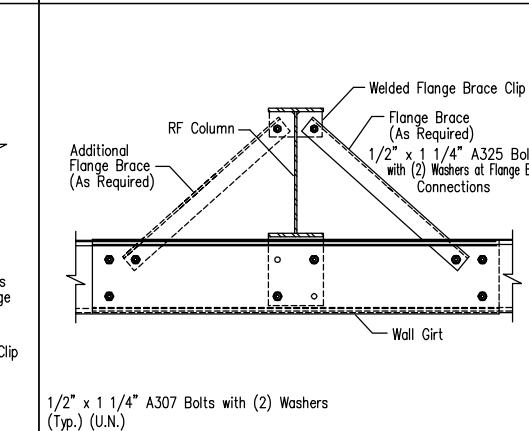


H2 WALL GIRT TO RIGID FRAME COLUMN

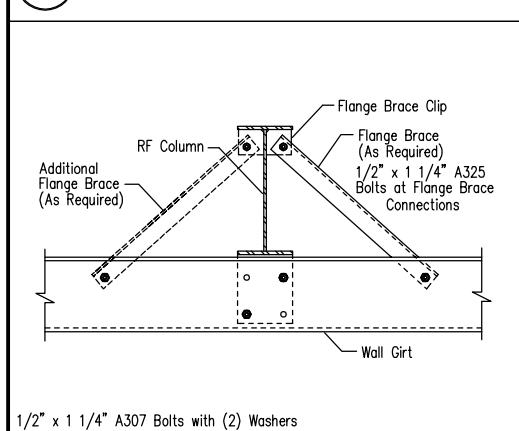


I19 WALL GIRT TO RIGID FRAME COLUMN

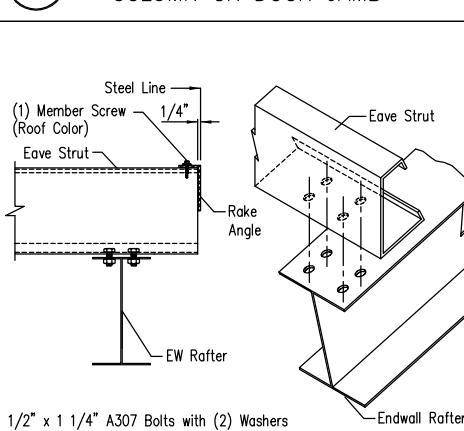


J8 LOW SIDE EAVE STRUT TO HOT ROLLED RAFTER

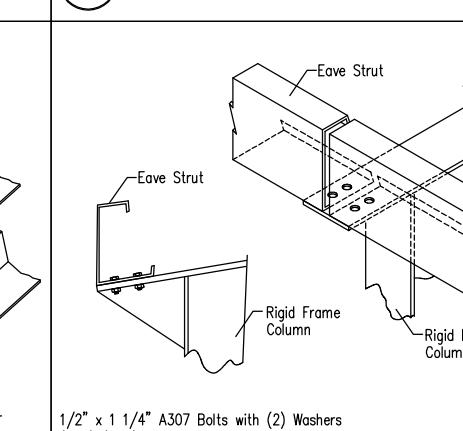


J2 EAVE STRUT TO RIGID FRAME

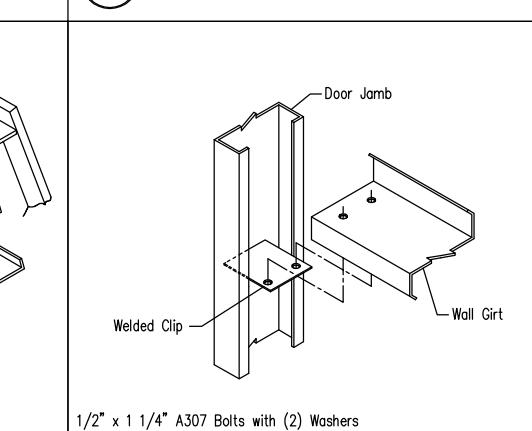


K3 WALL GIRT TO DOOR JAMB

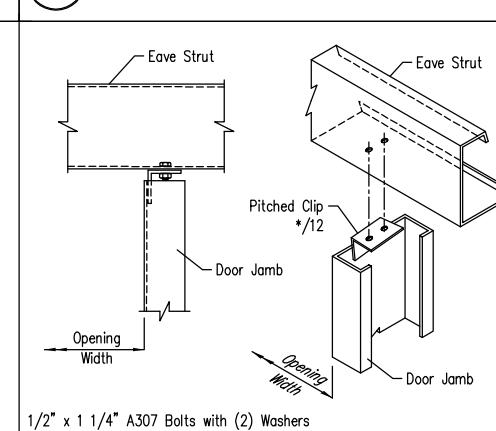


L3 DOOR JAMB TO EAVE STRUT

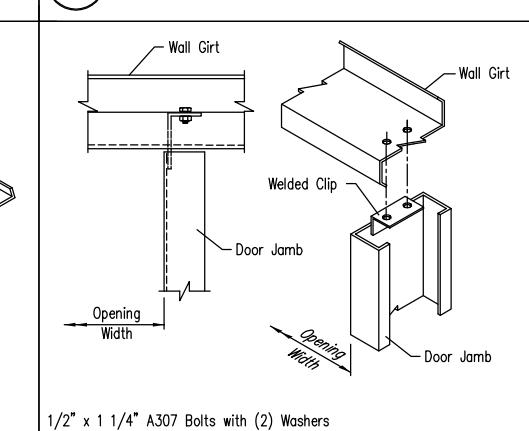


L8 DOOR JAMB TO WALL GIRT

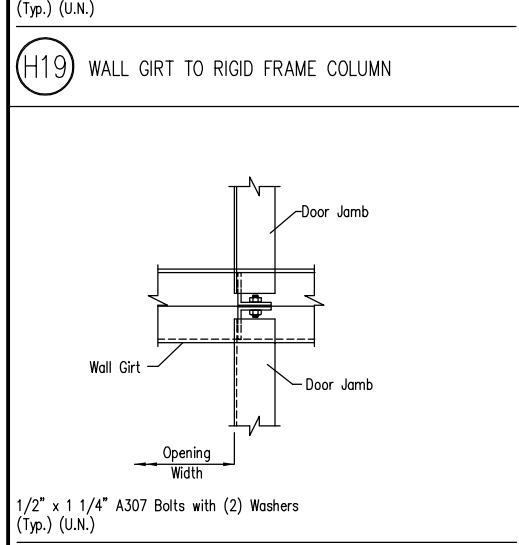

L9 DOOR JAMB TO WALL GIRT

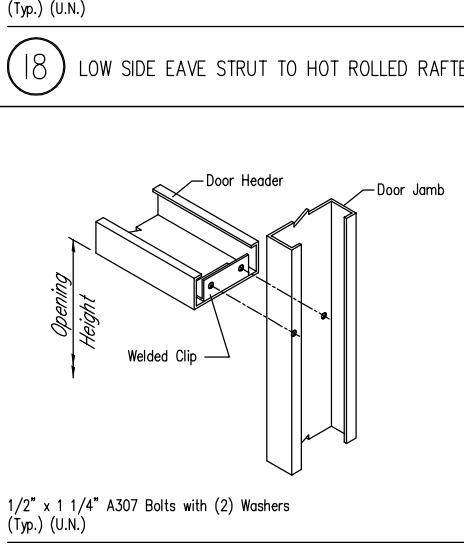

M3 DOOR HEADER TO DOOR JAMB

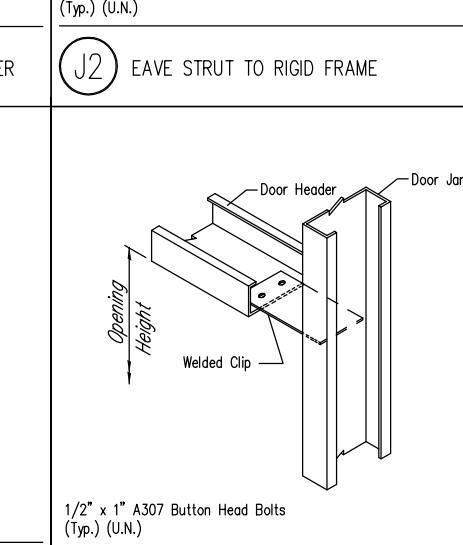

M4 DOOR HEADER TO DOOR JAMB

| ISSUE | DESCRIPTION | DATE | DRN. | CHK. | DES. | DESCRIPTION | DETAIL DRAWINGS |
|-------|------------------|----------|------|------|------|-------------|--|
| A | APPROVAL | 05.17.14 | CR | SRB | RA | CUSTOMER | RUVIN LERMAN |
| A1 | REVISED APPROVAL | 06.16.14 | RHS | SRB | RA | END USER | RUVIN LERMAN |
| P | PERMIT | 07.15.14 | CBR | RS | RA | END USE | GARAGE |
| P1 | REVISED PERMIT | 07.31.14 | DB | RAJ | RA | LOCATION | 2984 BLACK CANYON RD, CRAWFORD, CO 81415 |
| P2 | REVISED PERMIT | 08.29.14 | DB | TSP | RA | DES. BY: | RA |
| O | CONSTRUCTION | 03.11.15 | DB | SH | RA | DATE: | 08/26/14 |
| | | | | | | ENG. BY: | RA |
| | | | | | | DATE: | 08/26/14 |
| | | | | | | JOB NO.: | 53774R1 |
| | | | | | | SCALE: | N.T.S. |
| | | | | | | DWG. NO.: | 10 OF 12 |
| | | | | | | ISSUE: | 0 |

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