127 323 40100 OPTS 26 AMOUNT EXPIRATION **EXPLANATION** NUMBER THURSTON COUNTY HEALTH DEPARTMENT DIVISION OF ENVIRONMENTAL HEALTH 2000 LAKERIDGE DR. S.W. 11 PHONE 786-5455 OLYMPIA, WA 98502 71 OWNER (PLEASE-PRINT) **# 2970** 3/12/02 STREET CITY Any person Aggrieved by a decision an ZIP CODE inspection, or notice made by the health officer shall have the right to appeal the matter as specified in Article I. APPLICANT MAIL REPORT TO: NOTICE: The purpose of this permit or approval and 32. the regulations under which they are issued is only to protect against health hazards to the general public. It is not the purpose of the permit to guaranty that each septic Sec. 32, 17N, 2W Tract A system is constructed or will operate in compliance with regulations or in a successful manner. Issuance of a permit or approval is not a quaranty by the county regarding the adequacy of a site or sewage disposal system. PROJECT DESCRIPTION: NO. OF SINGLE-FAMILY BEDROOMS ☐ MOBILE HOME SEWAGE CONTRACTOR **□** DUPLEX ☐ FOR ON-SITE EVALUATION ONLY LOT SIZE LOT AREA SO, FT. 15980 SYSTEM OTHER **BASEMENT PLUMBING** ☐ YES REQUIRED TRENCH PROFILE SINGLE FAMILY ONLY WATER SYSTEM ☐ PUBLIC NAME EARTH COVER PAPER OR FABRIC STONE OVER PIPE PIPE STONE UNDER PIPE FEET TRENCH WIDTH FILTRATION AREA QUANTITY OF APPROVED STONE BUILDING SITE DISAPPROVED CU. YD. OTHER MATERIAL BUILDING SITE APPROVED GAL/SO, FT./DAY APPLICATION RATE GALLONS/DAY DESIGN FLOW BUILDING SITE APPLICATION EXPIRES MAXIMUM TRENCH DEPTH

HEALTH DEPARTMENT -- COUNTY OF THURSTON

I have this day inspected the sewage system on this property and have found the following violations of County and/or State laws governing same:

PERMIT NO. 2968 8

- Installation OK.

Need Designer out As-built / Pressure Page

You are hereby notified that no more work shall be covered on this property until the above violations are corrected. When corrections have been made, call for re-inspection.

DO NOT REMOVE THIS TAG

BUILDING SITE APPLICATION PROJECT PLAN

SITE NO. 37488 PARCEL NO. 32773 SEC. 100


INDICATE THE FOLLOWING INFORMATION. LABEL EXISTING OR PROPOSED, IF KNOWN, ON THE DRAWING. DRAW TO SCALE, USING 1 SQUARE TO EQUAL NO MORE THAN 10 FEET.

2711	10 000	AL.	• •	MONE THAT I O'LEET.			
	4		3.	Indicate north arrow. Property boundary lines. Indicate driveway location from nearest intersection or landmark. Major features of property (ravines, seasonal creeks, bodies of water).	□ 6. □ 7. □ 8. □ 9.	Wells or drinking water source. Paved surfaces (i.e. driveways and patios). Arrows showing direction of slope. Assume an elevation of 100 feet at one lot corner and indicate the other lot corner elvevations to it. Indicate structures — existing or proposed —	•

5. Proposed septic system location.

and distance from lot lines.

1.1 10. Neighbors wells within 150 feet.

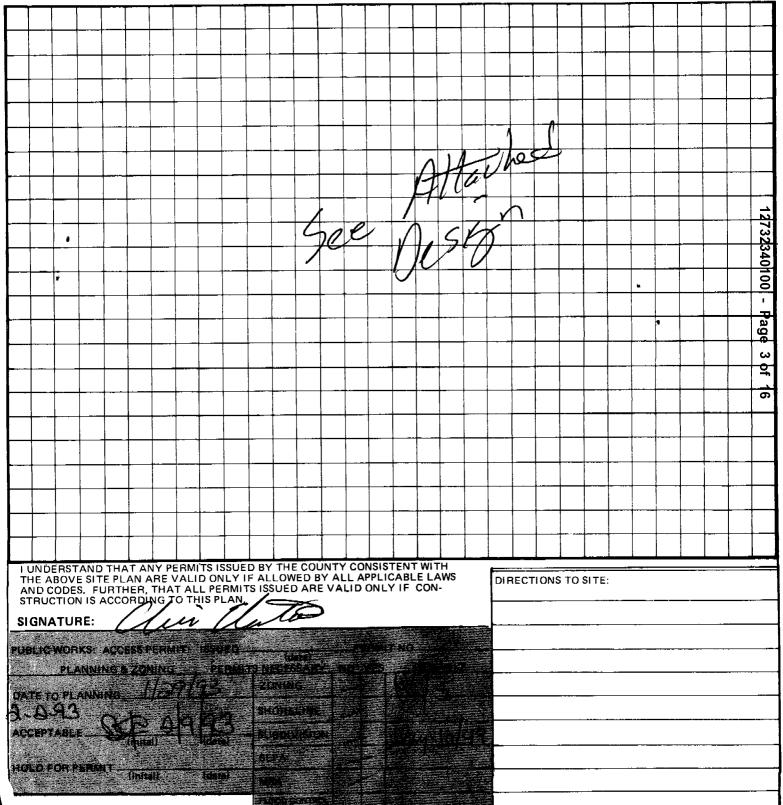

THURSTON COUNTY HEALTH DEPARTMENT (03) 2000 LAKERIDGE DR. S.W. OLYMPIA WA. 98502 PHONE 786-5455	FINAL INSPECTION RECORD THIS RECORD IS NOT A GUARANTEE OF PERFORMANCE. THE HEALTH DEPARTMENT RECOMMENDS THE SEPTIC TANK SHOULD BE PUMPED AND INSPECTED EVERY THREE TO FIVE YEARS. REDUCTION IN HOUSE WATER USE CAN EXTEND THE DRAINFIELD LIFE.		2 And A		RECEIVED BY THURSTON COUNTY ENV. HEALTH DATE 10/27/53
PARCEL # 12.22.3.4	INSTALLATION DATE 7/28/75 SEWAGE CONTRACTOR NO. SEPTIC CUBIC TANK SIZE 1200 YARDS ROCK 25	NDICATE THE FOLLOWING INFORMATERSIDENCE LOCATION AND DIMENSION PAVED SURFACES (I.E., PATIOS, DRIVE WELLS OR SURFACE WATER SOURCES DIRECTIONS OF DRAINAGE.	9. SEPTIC SYSTEM LOCATION. FROM HOUSE CORNER DRAINFIELD LENGTH AND LOCATION LOCATION & LENGTH OF ALL TIGHT LINES. 6. LENGTH, LOCATION & DIMENSIONS OF ALL INTERCEPTOR LINES. 7. LABEL ALL SETBACKS, I.E. FROM WATER, PROPERTY LINES, ROADS, ETC. 8. ASSUME AN ELEVATION OF 100 FEET AT OWN INDICATE THE OTHER LOT CORNER ELEVATION 9. USE ARROWS TO SHOW DIRECTION OF SLOBE ONE SQUARE EQUALS 10 FEET	Thench profile Thench profile Tobe Backfilled After in Special Stone under Pipe The Depths: The Backfilled The Depths: The Depth	TRENCH WIDTH TRENCH WIDTH DATE SOLVE STATE OF THE SOLVE STATE OF TH

127 323,40100

SITE NO.	29088 OPT\$26325 AREA: 103 PARCEL NO. 1273) 430	1000
DATE	RECORD OF ACTION	OPTS	ву
1/29/93	Mody, dwgn rock to TCP properwork	L	CH
2/11	returned from TCP, to 03		PS
2/24	on-ste		a,
3/9	Reviewed Sons - Approvable - as par dayner		
	justification the initial system will be	-	
i i	allowed within 90' of Seasonal discrease		WI
3/10	approvible, fele & Din to pupoue		<u></u>
3/11/03	opfer paid, copies released and file to DAM	V	HOW SON
1)-29-93		1	all -
7-30-93		-	1273
813	Final optsd. Refiled in Closed	V	<u> </u>
8.19	asbet attached, to area 3.	<i></i> ,	()N) 8
10/5	Hood dosigner coil on As-built		Page
10/8	The soil werd disigner cert		5 of
10/21	Designa signed of arbet, 4003.		16
11/28	allet and cining iled file to Oth		1040
11-1-93	asher april capies 1/sd. File to O'm Oun Complete	Mo	TW
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THURSTON COUNTY HEALTH DEPARTMENT ENVIRONMENTAL HEALTH DIVISION ON-SITE SEWAGE SYSTEM OPERATION AND MAINTENANCE PERMIT #107385

TAX PARCEL #12732340100

FILE COPY - PAGE 1

OS14 SINGLE FAMILY ON-SITE 4 YEAR PERMIT

BSA: 29688

CATEGORY: SINGLE FAMILY EXPIRATION DATE: 07/28/1997

AUDITOR FILE NUMBER:

SANITARIAN: 67382 SEC 32 TWN 17 RNG 2W

SYSTEM TYPE: PRESSURE DIST

GPD: 360 ERU: 1.0 DENSITY: N

GSA DESCRIPTION:

COMMENT:

THIS PERMIT IS GRANTED UNDER PROVISIONS OF RCW 70.05, WAC 248-96, AND ARTICLE IV, THURSTON COUNTY SANITARY CODE THIS DATE OF 07/29/1993.

TO:

GREGORY & SUSAN ADAMICH

12221 CASE RD SW OLYMPIA, WA 98512

LEGAL DESCRIPTION: E2 W2 LY S OF FOL LN COM E LN SW TR 12225 CASE RD SW OLYMPIA, WA 98512

THE PERMITTEE IS HEREBY ISSUED AN OPERATION AND MAINTENANCE PERMIT FOR AN ON-SITE SEWAGE DISPOSAL SYSTEM ON THE ABOVE DESCRIBED PROPERTY WHICH IS SUBJECT TO THE FOLLOWING CONDITIONS:

- * ALL INSPECTIONS, MAINTENANCE COMMENTS, RECORDINGS AND REPAIRS SHALL BE KEPT IN A LOG BOOK; A COPY OF WHICH SHALL BE SUBMITTED TO THURSTON COUNTY ENVIRONMENTAL HEALTH PRIOR TO EXPIRATION OF THIS PERMIT.
- * THE SEPTIC TANK(S) MUST BE PUMPED BY A LICENSED PUMPER DURING THE LAST SIX MONTHS PRIOR TO THE PERMIT EXPIRATION DATE, UNLESS OTHERWISE AUTHORIZED BY THE HEALTH OFFICER.
- * WRITTEN EVIDENCE FROM A LICENSED SEPTIC TANK PUMPER THAT THE TANK(S) AND\OR PUMP CHAMBER HAVE BEEN PUMPED MUST BE PRESENTED TO THE ENVIRONMENTAL HEALTH DIVISION PRIOR TO THE EXPIRATION OF THIS PERMIT. THERE SHALL ALSO BE A STATEMENT FROM THE PUMPER REGARDING THE CONDITION OF THE SEPTIC TANK AND\OR PUMP CHAMBER.
- * DRAINFIELD AREAS AND/OR INSPECTION PORT(S) MUST BE VISUALLY INSPECTED EACH SPRING. RESULTS OF THE INSPECTIONS MUST BE NOTED IN THE INSPECTION LOG BOOK.
- * THE PUMP CHAMBER MUST BE INSPECTED EVERY TIME THE SEPTIC TANK IS PUMPED. CHECK THE CONDITION AND PROPER PERFORMANCE OF THE SWITCH, PUMP/SIPHON, SCREEN AND ALARMS. ELECTRICAL COMPONENTS AND CONDUITS SHOULD BE CHECKED FOR CORROSION. BUILD-UP OF SLUDGE IN THE CHAMBER SHOULD BE MONITORED AND PUMPED IF NEEDED.
- * THE PUMP CHAMBER SHOULD BE INSPECTED EVERY SIX (6) MONTHS. THE CONDITION OF THE PUMP CHAMBER SHOULD BE NOTED.

STATEMENT OF RECORD

Tax Parcel #12732340100

Legal Description: E2 W2 LY S OF FOL LN COM E LN SW TR
A SURVEY 10/4

An Operation and Maintenance Permit #107385 has been issued on this parcel of property. This permit is required by Article IV of the Thurston County Sanitary Code to insure proper operation and maintenance of the on-site sewage disposal system located on the above described property. This permit shall be obtained and kept current by the owner of such property.

This document shall run with the land and shall be binding on all parties, their successors in interest and assigns, having or acquiring any right, title, or interest in the land described herein or any part thereof, and shall insure to the benefit of each owner thereof.

For information regarding specific permit conditions, contact Thurston County Environmental Health, Operation and Maintenance permit section, at 754-3348.

GREGORY & SUSAN ADAMICH

Legal Owner's Printed Name

Health Inspector's Signature

0-29-93

Date

-FOR AUDITOR'S USE ONLY-

THURSTON COUNTY
OLYMPIA, WA
10/29/93 1:41 PM
REQUEST OF: 107385
Sam S. Reed, AUBITOR
BY: ALAN, DEPUTY
\$7.00 EHSRD

Vol: 2176 Page: 156 File No: 9310290247

THURSTON COUNTY HEALTH DEPARTMENT ENVIRONMENT HEALTH DIVISION ON-SITE SEWAGE SYSTEM OPERATION AND MAINTENANCE PERMIT #107385

TAX PARCEL #12732340100

BILLING STATEMENT

0514	SINGLE	FAMILY	ON-SITE	4	YEAR	PERMIT
------	--------	--------	---------	---	------	--------

ERU: 1.0

GREGORY & SUSAN ADAMICH	BILLING DATE: 07/29/1993
12221 CASE RD SW	PAYMENT DUE DATE: 08/28/1993
OLYMPIA, WA 98512	PERMIT EXPIRATION DATE: 07/28/1997

Fee Calculations For Current Year

07/29/1993	Operational Permit Administration Fee	\$33.00	
07/29/1993	Auditor Filing Fee	\$7.00	
07/29/1993	Water Quality Monitoring Fee	\$30.00	
Balance Due			\$70.00

Anticipated Future Fees*

07/29/1994 Wa	ater Quality Monitoring		\$30.00
07/29/1995 Wa	ater Quality Monitoring	Fee	\$30.00
	ater Quality Monitoring	Fee	\$30.00
07/29/1997 F	ield Inspection Fee		\$60.00

Anticipated Future Fees for this Permit	\$150.00
Total Estimated Fees for this Permit	\$220.00

* Fees subject to change for inflation, etc, as allowed in Article I of Thurston County Sanitary Code

CHECKS PAYABLE TO:

ENVIRONMENTAL HEALTH

MAILING ADDRESS:

THURSTON COUNTY HEALTH DEPARTMENT

ENVIRONMENTAL HEALTH SECTION

2000 LAKERIDGE DRIVE SW, BUILDING 1

OLYMPIA, WA 98502



COUNTY COMMISSIONERS

Judy Wilson District One

Diane Oberquell
District Two

Dick Nichols District Three

PUBLIC HEALTH AND SOCIAL SERVICES DEPARTMENT

Patrick M. Libbey, Director Diana T. Yu, MD, MSPH Health Officer

October 6, 1993

Johnson & Maddox 2209 93rd Ave SW Olympia, WA 98502

SUBJECT:

AS-BUILTS

BUILDING SITE APPLICATION # 29688, 29700, 29049 TAX PARCEL # 12732340100, 09180014003, 79070001800

Dear Johnson & Maddox:

Review of the above mentioned as-built drawings reveals deficiencies that should be corrected before the sewage system receives approval by this Department, designer certification is needed for each of these as-builts.

Please submit a revised drawing on the as-built form. The sewage system records will be reviewed for final approval upon receiving the revision.

If you have any further questions regarding this matter, please contact me at (206) 754-2964.

Sincerely,

Walt Tysinger

Environmental Health Specialist

/dkp

CC: Wayne Sandy; PO Box 205; Rochester, WA 98579
Michael's Construction; PO Box 685; East Olympia, WA 98540
Gregory Adamich; 12221 Case Road SW; Olympia, WA 98512
Goode & Associates; PO Box 854; Centralia, WA 98531
Advanced Septic Designs; 4305 Lacey Blvd; Lacey, WA 98503
Johnson & Maddox, Installer file

A-29049/area3/dkp



4305 LACEY BLVD. S.E. LACEY, WA 98503

> PHONE: 491-4044 FAX: 493-0431

/- 29-93


Don Moulton, Gary Duvall Thurston Co. Env. Health


Re: TP # 12732430000 (Greg Adamich)

Dear Don/Gary,

Attached is the septic system design for the above referenced site. The primary brainfield is proposed in the deepest freedraining soil available at this site. Although a seasonal drainage course runs ±90' from the proposed d.f., the ground slopes away from the drainage. This, combined with the excellent dispersion of the pressurized system, should ensure that there will be no adverse effect on the local public or environmental health. Thus, a ±10' set back reduction from the 100 setback Please review ASAP, Thank you Clien E.

MEMBER: AMERICAN SOCIETY OF CIVIL ENGINEERS

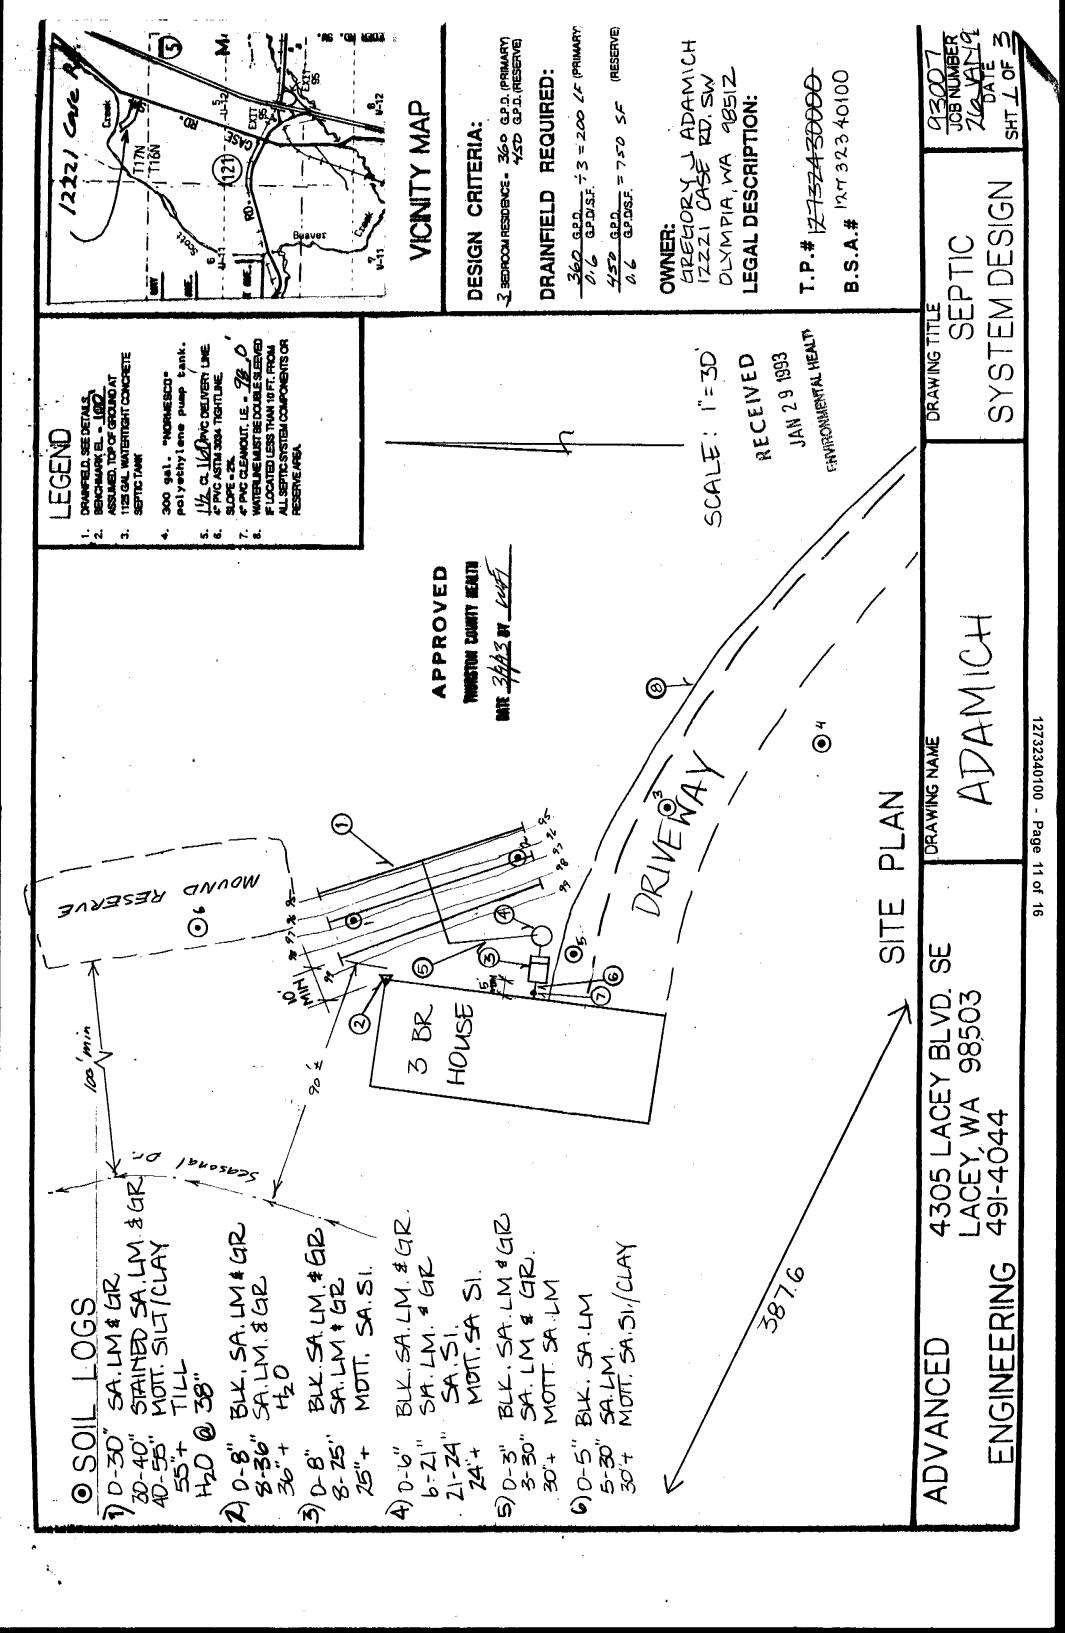

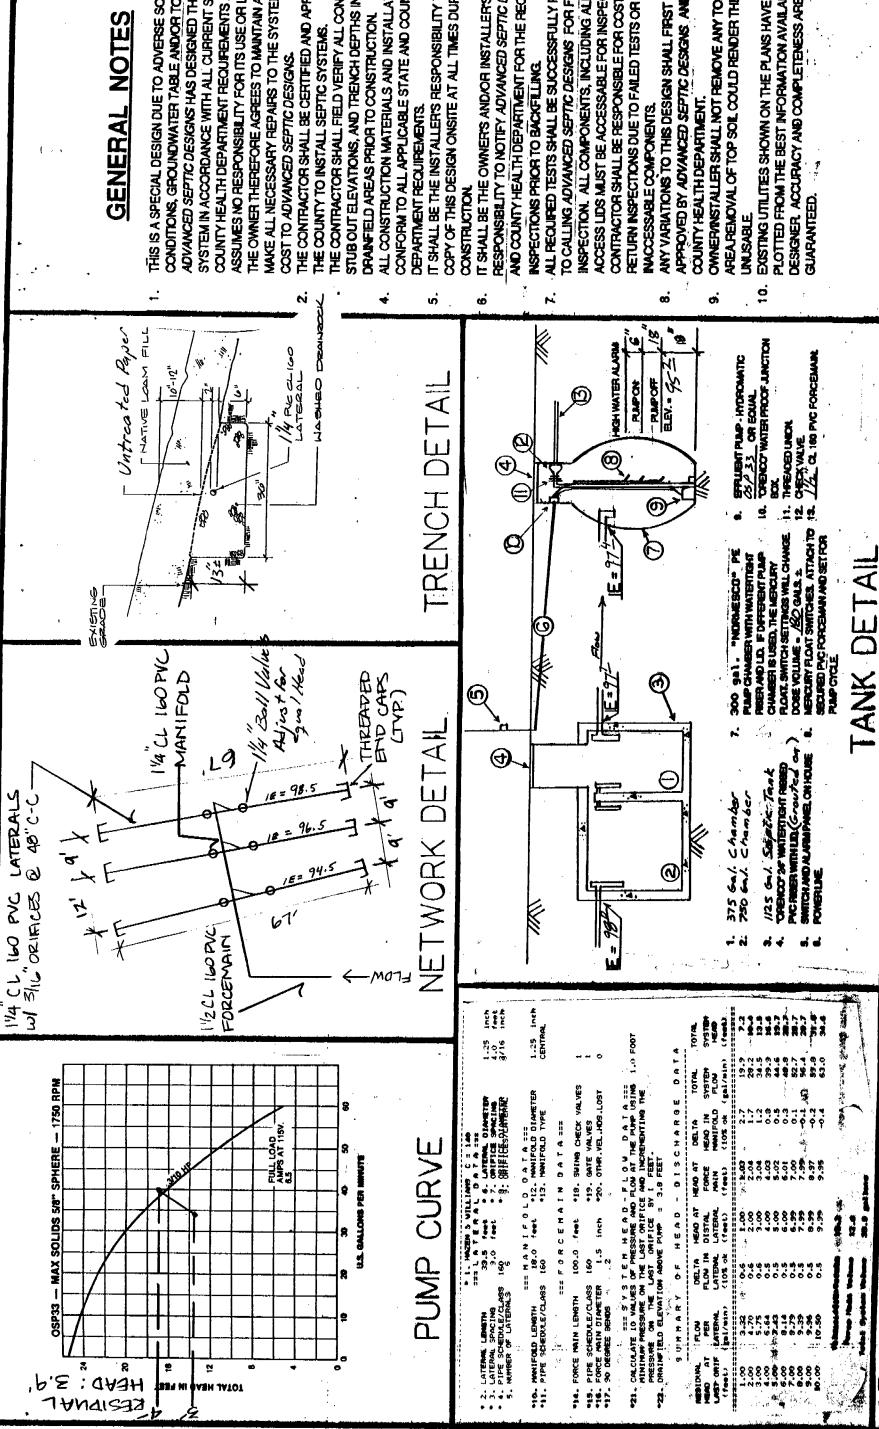

GENERAL NOTES

CONDITIONS, GROUNDWATER TABLE ANDIOR TOPOGRAPHY ASSUMES NO RESPONSIBILITY FOR ITS USE OR LONGEVITY; SYSTEM IN ACCORDANCE WITH ALL CURRENT STATE AND MAKE ALL NECESSARY REPAIRS TO THE SYSTEM AT NO COUNTY HEALTH DEPARTMENT REQUIREMENTS AND THE OWNER THEREFORE AGREES TO MAINTAIN AND ADVANCED SEPTIC DESIGNS HAS DESIGNED THIS THIS IS A SPECIAL DESIGN DUE TO ADVERSE SOIL COST TO ADVANCED SEPTIC DESIGNS.

THE CONTRACTOR SHALL BE CERTIFIED AND APPROVED BY THE CONTRACTOR SHALL FIELD VERIFY ALL CONTOURS, STUBOUT ELEVATIONS, AND TRENCH DEPTHS IN DRAINFIELD AREAS PRIOR TO CONSTRUCTION. THE COUNTY TO INSTALL SEPTIC SYSTEMS.

CONFORM TO ALL APPLICABLE STATE AND COUNTY HEALTH ALL CONSTRUCTION MATERIALS AND INSTALLATION SHALL IT SHALL BE THE INSTALLER'S RESPONSIBILITY TO HAVE A DEPARTMENT REQUIREMENTS.

RESPONSIBILITY TO NOTIFY ADVANCED SEPTIC DESIGNS COPY OF THIS DESIGN ONSITE AT ALL TIMES DURING IT SHALL BE THE OWNER'S AND/OR INSTALLER'S CONSTRUCTION

ALL REQUIRED TESTS SHALL BE SUCCESSFULLY RUN PRIOR AND COUNTY HEALTH DEPARTMENT FOR THE REQUIRED INSPECTION. ALL COMPONENTS, INCLUDING ALL TANK ACCESS LIDS MUST BE ACCESSABLE FOR INSPECTION. CONTRACTOR SHALL BE RESPONSIBLE FOR COSTS OF TO CALLING ADVANCED SEPTIC DESIGNS FOR FINAL INSPECTIONS PRIOR TO BACKFILLING

APPROVED BY ADVANCED SEPTIC DESIGNS AND THE ANY VARIATIONS TO THIS DESIGN SHALL FIRST BE COUNTY HEALTH DEPARTMENT.

OWNER/INSTALLER SHALL NOT REMOVE ANY TOP SOIL IN BAR. AREA PENOVAL OF TOP SOIL COULD RENDER THE SITE

PLOTTED FROM THE BEST INFORMATION AVAILABLE TO THE EXISTING UTILITIES SHOWN ON THE PLANS HAVE BEEN DESIGNER, ACCURACY AND COMPLETENESS ARE NOT

and a graph of the property of


LACEY BLVD. 98503 491-4 ENGINEERING

AD A MICH

DRAWING NAME

SYSTEM DESIGN SEPTIC DRAWING TITLE

43001 JOB NUMBER され

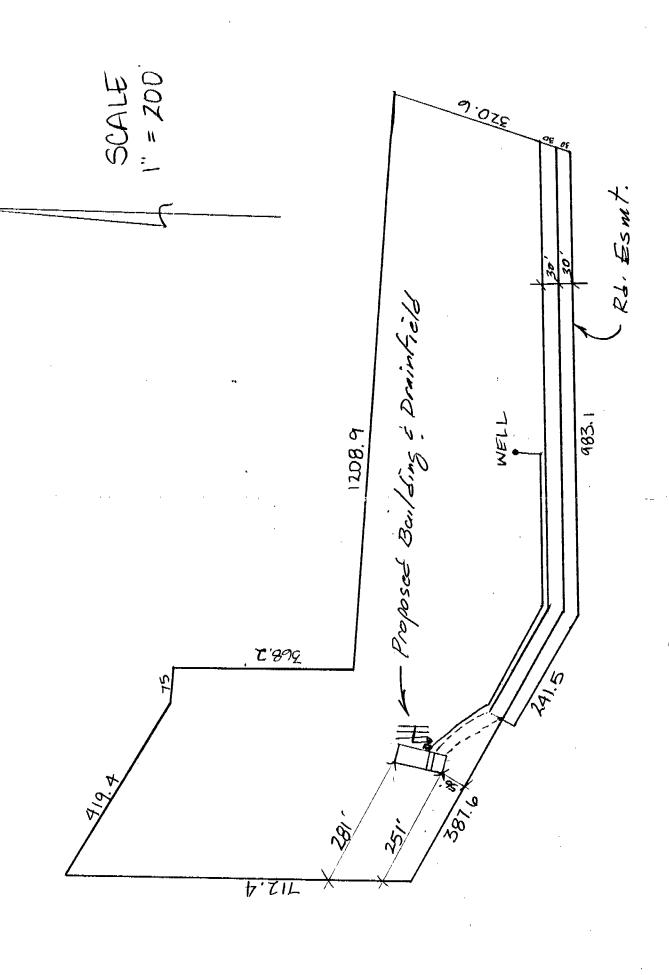

OVERALL SITE PLAN


ADVANCED

LACEY BLVD, SUITE 4 7, WA 98503 Y, ₩A .044 4305 LACEY 491-40 ENGINEERING

BAMICH

DRAWING NAME

SYSTEM DESIGN DRAWING TITLE SEPTIC

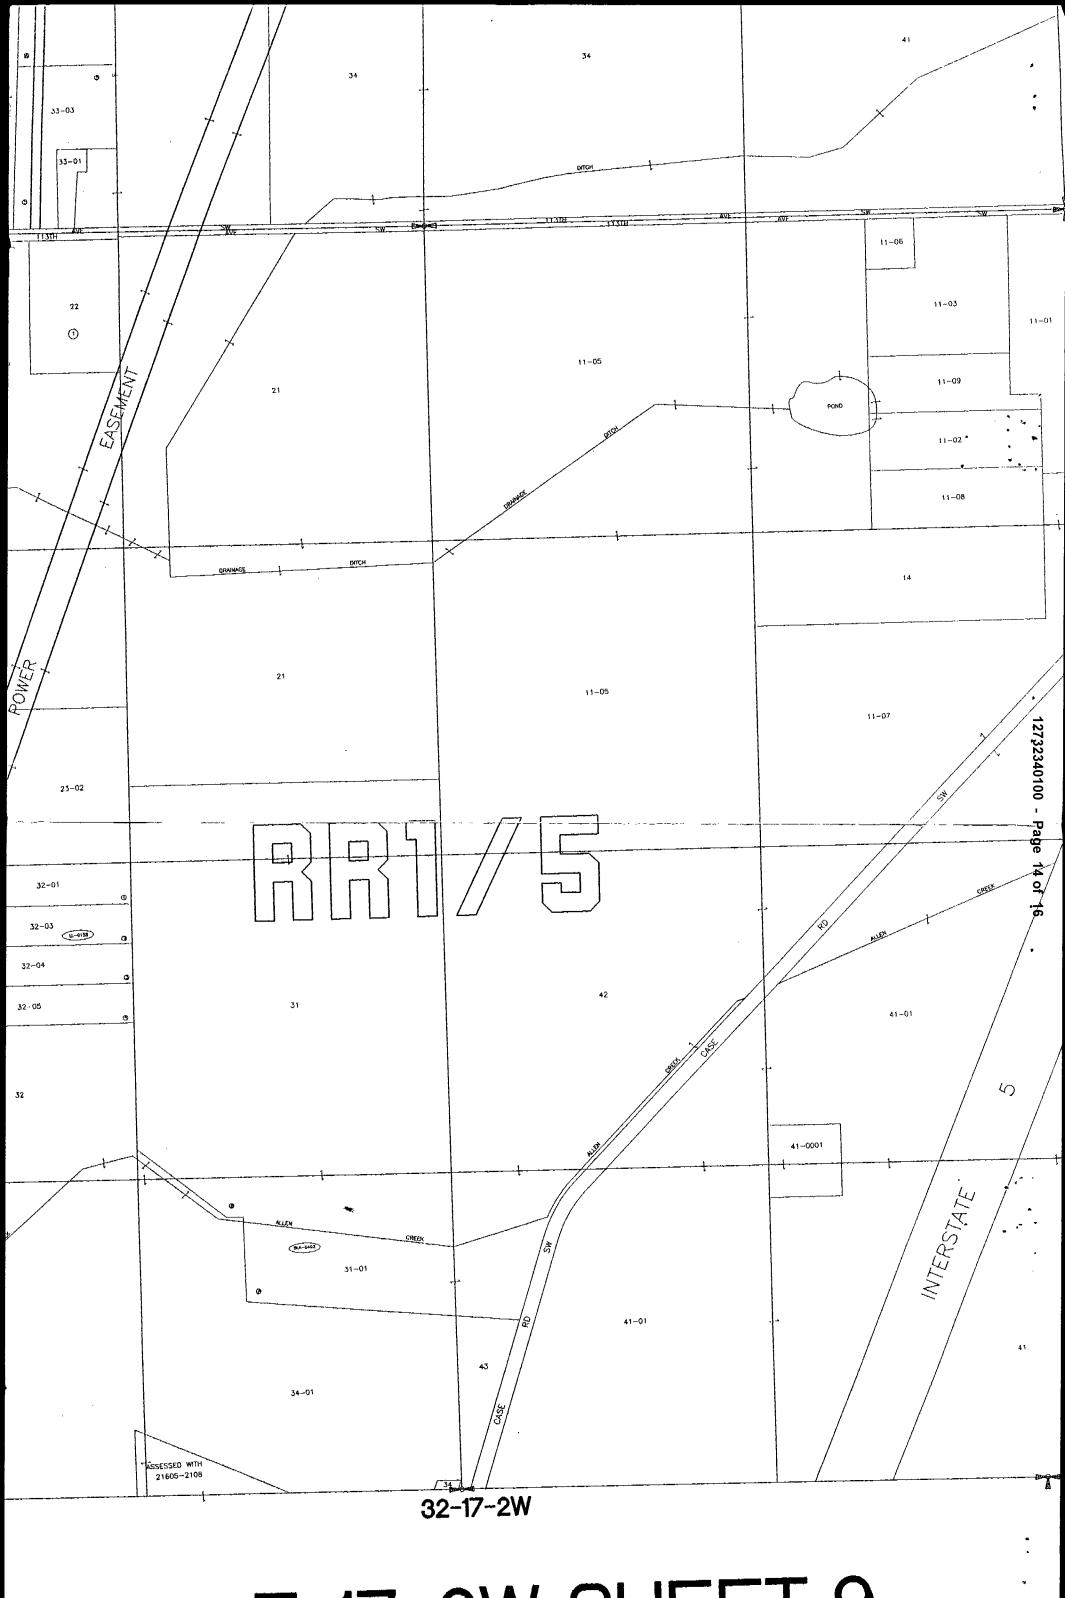

T-17-2W SHFFT 9



DIVISION OF ENVIRONMENTAL HEALTH

2000 LAKERIDGE DR. S.W. OLYMPIA, WA 98502

PHONE 753-8073

Site No. 8014

Parcel No. 127-32-340 (

DESIGN CHECKLIST

The following items are required to be addressed in sewage system design. **Items circled are not required** for this design submission. The design should include the following items:

- 1. Scale 1'' = 20' preferred, 1'' = 30' maximum. Other scales by approval of health officer
- 2. North arrow
- 3. Location of property corners
- 4. Location, size, shape and placement of all buildings on the site
- 5. Locations of all wells on the property and adjacent properties within 100 feet of the proposed sewage disposal system
- 6. Location, size and shape of drainfield and reserve area
- 7. Location and size of septic tank and manufacturer's name
- 8. Location and distance from the drainfield, reserve area and septic tank to the following items:
 - a. Wells on the property and adjacent properties within 100 feet
 - b. Water supply lines and utilities
 - c. Property lines
 - d. Easements
 - e. Open ditches, cuts, banks
 - f. Surface waters
 - g. Buildings
 - h. Crests of slopes, fills
 - i. Surfaced areas
- 9. Location, direction of flow and discharge point of all surface water and/or interceptor drains. (May require groundwater discharge points.)
- 10. Location of soil log holes to a minimum of four feet. At least two soil log holes are required in the drainfield area and one or more in the reserve area.
- 11. Location and depth of percolation tests
- 12. Results of percolation tests including date run
- 3 Location and depth of soil sieve samples
- 14. Topography lines (2' up to 10% and 5' over 10% slope)
- 15. Reference bench mark and stated elevations
- 16. Elevations of the following:
 - a. Plumbing stubout
 - b. Septic tank inlet
 - c. Drainfield pipe invert
- 17. Results of all required soil logs
- 18. Calculations for drainfield requirements and septic tank size
- 19. Cross section detail of the drainfield trench and interceptor trench and pertinent construction details and methods
- 20. Backfill requirements (material, depth, method placed, cover planting, etc.)
- 21. Pump specifications and pump chamber size, if required

Special treatment devices (aeration tank, up-flow filter, chlorinator) if required (In conformance with state guidelines)

23) Check to see if community water is approved

1f mound or pressure system — in conformance with state guidelines. Fill out mound worksheet or attach your calculations.

- 25. Owner/resident designs require a copy of the property deed or real estate contract as proof of ownership.
- 26. Trees and obstacles to be removed from drainfield area (marked on map and flagged on site) and method of removal
- 27. Site preparation specifications or instructions
- 28. Elevation differences from water bodies and drainfield, if needed

29.	Does the design propose a reduction in standards or D.S.H.S	i. guidelines?
	Is justification provided?	

- ☐ 30. The following items require resolution prior to building site application approval and release:
 - a. Signed and notarized Hold Harmless form
 - b. Easements if required

Operational Permit and covenant if required

Flood Control Permit if required e. Any other permits or approval as required by law	
0/29/81	P. Dames Coche
DATE	ENVIRONMENTAL HEALTH SECTION
•	١,

12732340100 - Page 16 of 16

THURSTON COUNTY HEALTH DEPARTMENT
DIVISION OF ENVIRONMENTAL HEALTH
2000 LAKERIDGE DR. S.W. OLYMPIA, WA 98502
PHONE 753-8073

Parcel No. 127-32-3401

Site No. 8014

EVALUATION PROCESS FOR ON-SITE SEWAGE DISPOSAL

·Check marks indicate items that are acceptable or resolved. See comm	nents section for items not checked.
A. Office and Preliminary Determinations	
1. Plot plan complete enough to start review 2. Application complete enough to start review 3. Plot plan cleared other departments 4. Public sewer availability 5. Flood Control Zone required No Yes Permi 6. Water Supply Approved Single Family West Fig. 7. Design Flow Under 1200 GPD 1200 GPD or Greater 8. Geologically sensitive area No 9. Operational Permit required No 10. Is design required by information now available? Yes	
B. Field Evaluation	
11. Compare plat plan to site	
12. Locate proposal and test holes on plat plan and site	2 3
13. Soil Evaluation 14. Test hole depth	± 42"
15 Depth to standing water	
☐ 16. Depth to mottling	FAUT AT 42"
17. Depth to winter high water table	
18. Depth to impermeable layer 19. Soil Texture 1. SEN GEAUELLY SILTY SAND LOAY	VATER
19. Soil Texture 1	
3	
20. SCS Soll Type ALDERWOOD	
21. Soil stratification	
22. Soil structure	
23. Soil shrink/swell factor	filled Jo
Has the soil been disturbed No	filled No
 25. Are there water table indicating plants? 26. Is permeable soil deep enough to obtain three foot separation v 	vith standard system?
26. Is permeable soft deep enough to obtain these root opportunity	
28. Aguifer protection ??	
29 Distance to water table ?*	
30. Flooding or extreme high water table in wet years	
	Excessive slope
SwalesDepressionsToe of Slope	Other
Hummocky	
32. Distances from proposed drainfield and reserve area to:	
	7. Waterlines
2. Wells5. Ditches6. Intercepter Ditches	8. Buildings 9. Property Lines
age Conditions or combinations of conditions that would cause a h	health hazard DEAILIFIELD DISTALLED INTO UNTER IABLE
diagonal problem	em FLOOGO DEALUFIELD AND SUPFACING EFFLUENT
, disposal probl	or code violation
34. Proposal approvable as submitted	
Proposal approvable with revisions	
36 Comments: A DESIGNED OU-SITE SENAGE	SUSTEN WILL BE COUSIDERED FOR THIS
5:[4.	
t 1	00 0
10/29/81	J. Davell Cochra-
DATE	ENVIRONMENTAL HEALTH SECTION